BID SET

01.06.25



Clackamas Fire District: Station 12

18081 S Harding Rd Oregon City, OR 97045

THESE DRAWINGS ARE THE ORIGINAL UNPUBLISHED WORK	OF THE ARCHITECT AND MAY NOT BE DUPLICATED OR USED	WITHOUT THE WRITTEN CONSENT OF THE ARCHITECT.	
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GENERAL PROJECT NOTES PROJECT TEAM PROJECT SUMMARY REFER TO OWNER-CONTRACTOR AGREEMENT FOR GENERAL CONDITIONS. WHERE CLACKAMAS FIRE DISTRICT #1 PROJECT ADDRESS: 18081 S. HARDING RD, OREGON CITY, OR 97045 THERE IS A CONFLICT BETWEEN THE CONTRACT AND NOTES HEREIN, THE CONTRACT 11300 SE FULLER RD MILWAUKEE, OR 97222 TAKES PRECEDENCE. TAX LOT: #23E3401202 TEL: 503.793.6158 FAX: Fax LEGAL DESCRIPTION: SECTION 34, TOWNSHIP 2S, RANGE 3E, TAX LOT 01202 CONTACT: DENISE TOYOOKA GENERAL CONTRACTOR IS RESPONSIBLE FOR THE FULL SET OF CONSTRUCTION EMAIL: denise.toyooka@clackamasfire.com DOCUMENTS, INCLUDING BUT NOT LIMITED TO DRAWINGS, SPECIFICATIONS, AND ZONING: EFU - EXCLUSIVE FARM USE DISTRICT SITE AREA: 1.96 ACRES THE CONTRACTOR SHALL FIELD VERIFY ALL CONDITIONS AND DIMENSIONS PRIOR TO SCOTT EDWARDS ARCHITECTURE. LLP ARCHITECT ANY WORK AND SHALL BE RESPONSIBLE FOR ALL WORK AND MATERIALS INCLUDING **BUILDING AREA:** 5,383 SF (NO NEW ADDITIONS PROPOSED) 2525 E. BURNSIDE STREET THOSE FURNISHED BY SUBCONTRACTORS. PORTLAND, OREGON 97214 YEAR BUILT: 1980 TEL: 503.226.3617 DIMENSIONS TAKE PRECEDENCE OVER DRAWINGS: DO NOT SCALE DRAWINGS TO FAX: 503.226.3715 DETERMINE ANY LOCATIONS. THE ARCHITECT SHALL BE NOTIFIED OF ANY EXISTING OCCUPANCY: CONTACT: TOM BYRNE DISCREPANCY PRIOR TO CONTINUING WITH WORK. SHEET INDEX EMAIL: tbyrne@seallp.com EXISTING USE: FIRE STATION WITH SLEEPING LOFT (2nd FLOOR) GENERAL CONTRACTOR SHALL KEEP THE CONSTRUCTION SITE IN A BROOM CLEAN CONDITION AT ALL TIMES DURING THE PROJECT. SEISMIC UPGRADE: 2016, PERMIT NO. B0360116 SHEET# SHEET NAME STRUCTURAL WDY, INC. THE CONTRACTOR SHALL REPORT TO THE ARCHITECT ANY ERRORS, INCONSISTENCIES WATER SUPPLY: WELL 6443 SW BEAVERTON-HILLSDALE HWY, SUITE 210 **ENGINEER** OR OMISSIONS HE OR SHE MAY DISCOVER. BRING UNFORESEEN CONDITIONS TO PORTLAND, OREGON 97221 GENERAL ATTENTION OF ARCHITECT UPON DISCOVERY AT ANY POINT. THE MEANS OF DRAINFIELD AND SEPTIC TANK SEWAGE DISPOSAL: TEL: 503.203.8111 CORRECTING ANY ERROR OR UNFORESEEN CONDITION SHALL FIRST BE APPROVED BY G0.01 GENERAL PROJECT INFORMATION CONTACT: DALE DILORETO THE ARCHITECT. ONSITE WASTEWATER EXISTING SYSTEM VERIFICATION EMAIL: dale@wdyi.com G1.01 CODE SUMMARY & FIRE LIFE SAFETY REPORT PROVIDED BY OWNER. ALL REQUIRED CITY AND/OR COUNTY LICENSE SHALL BE ACQUIRED AND PAID FOR BY DATE OF INSPECTION: 6/13/2024 THE INDIVIDUAL TRADE. PERFORMED BY: PAUL M FISHER ARCHITECTURAL LICENSE NO: RM-49 THE ARCHITECT WILL REVIEW SHOP DRAWINGS AND SAMPLES FOR CONFORMANCE COMPANY: BYERS SEPTIC TANK SERVICE INC. ARCHITECTURAL GENERAL NOTES AND DIAGRAMS INTERFACE ENGINEERING, INC WITH THE DESIGN CONCEPT OF THE PROJECT. THE ARCHITECT'S REVIEW OF A MECHANICAL SEPARATE ITEM SHALL NOT INDICATE APPROVAL OF AN ASSEMBLY IN WHICH THE ITEM 100 SW MAIN ST, #1600 **ENGINEER** A1.01 SITE PLAN/ EXTERIOR ELEVATIONS PORTLAND, OR 97204 RENOVATION OF EXISTING 2-STORY WOOD FRAMED FIRE PROJECT DESCRIPTION: A2.01 DEMOLITION PLANS TEL: 503.382.2266 STATION FOR CLACKAMAS FIRE DISTRICT STATION 12. IT SHALL BE THE RESPONSIBILITY OF THE CONTRACTOR TO VERIFY LOCATION OF ALL CONTACT: AARON SCHIESS FLOOR PLANS A2.11 FIRE STATION TO NOW HAVE FULL TIME DEDICATED STAFF. EXISTING UTILITIES WHETHER SHOWN HEREIN OR NOT AND TO PROTECT THEM FROM EMAIL: aaronsc@interfaceeng.com DAMAGE. THE CONTRACTOR SHALL BEAR ALL EXPENSES OF REPAIR OR INTERIOR ELEVATIONS SITE IMPROVEMENTS REPLACEMENT OF UTILITIES OR OTHER PROPERTY DAMAGED BY OPERATIONS IN RESTRIPE ACCESSIBLE PARKING AREA AND PAVEMENT STRIPING A9.01 INTERIOR DETAILS CONJUNCTION WITH THE EXECUTION OF THE WORK. FOR TRUCK LANES. SCHEDULES AND FINISHES A10.01 CITY APPROVED PLANS SHALL BE KEPT IN A SECURE PLACE AND SHALL NOT BE USED **ELECTRICAL** INTERFACE ENGINEERING, INC EXTERIOR IMPROVEMENTS BY WORKERS. THE CONTRACTOR SHALL BE RESPONSIBLE THAT ALL **ENGINEER** 100 SW MAIN ST. #1600 NO IMPROVEMENTS PROPOSED SUBCONTRACTORS' CONSTRUCTION SETS REFLECT THE SAME INFORMATION. THE STRUCTURAL PORTLAND, OR 97204 CONTRACTOR SHALL ALSO MAINTAIN, IN GOOD CONDITION, ONE COMPLETE SET OF TEL: 503.382.2704 INTERIOR IMPROVEMENTS STAMPED CITY APPROVED PLANS WITH ALL REVISIONS, ADDENDUMS, AND CHANGE STRUCTURAL NOTES AND ABBREVIATIONS S1.01 RENOVATE LIVING AND SLEEPING AREAS OF THE EXISTING CONTACT: TESS ELLSWORTH ORDERS ON THE PREMISES AT ALL TIMES. THESE ARE TO BE UNDER THE CARE OF THE S2.01 FACILITY THAT INCLUDES THE FOLLOWING: MAIN & UPPER LEVELS PLANS EMAIL: tesse@interfaceeng.com JOB SUPERINTENDENT AND MUST BE MADE AVAILABLE TO BUILDING AND FIRE DIVIDING DORM AREA INTO TWO SEPARATE SLEEPING ROOMS. INSPECTIONS FOR REFERENCE DURING CONSTRUCTION. S3.01 **DETAILS** CHANGE (E) OFFICE TO FUTURE DORM ROOM. ALL NEW KITCHEN CABINETS AND APPLIANCES. RENOVATE (E) RESTROOMS AND 0. THE CONTRACTOR SHALL BE RESPONSIBLE FOR THE COMPLETE SECURITY OF THE REPLACE PLUMBING FIXTURES UNO. UPGRADE FINISHES WITH SITE WHILE THE JOB IS IN PROGRESS AND UNTIL JOB COMPLETION. ALL NEW BASE, TRIM, PAINT, ETC. PLUMBING INTERFACE ENGINEERING, INC 11. THE CONTRACTOR SHALL TAKE ALL NECESSARY PRECAUTIONS TO ENSURE THE 100 SW MAIN ST, #1600 **ENGINEER** SAFETY OF THE OCCUPANTS AND WORKERS AT ALL TIMES. PORTLAND, OR 97204 REINFORCE SECOND FLOOR AT GYM AREA WITH ADDED JOISTS TEL: 503.382.2734 AND PLYWOOD SUB-FRAMING 12. THE CONTRACTOR IS SOLELY RESPONSIBLE FOR ALL CONSTRUCTION MEANS AND CONTACT: TODD KOLIBABA METHODS AND SHALL MAINTAIN THE STRUCTURAL INTEGRITY OF ANY CONSTRUCTION. EMAIL: toddk@interfaceeng.com MEP IMPROVEMENTS: DESIGN-BUILD MECHANICAL HVAC - EXISTING SYSTEMS ARE OLDER AND WILL 3. THE CONTRACTOR SHALL BE RESPONSIBLE FOR AND SHALL REPLACE OR REMEDY ANY BE REPLACED WITH NEW FAULTY, IMPROPER, OR INFERIOR MATERIALS OR WORKMANSHIP WHICH SHALL ELECTRICAL - ALL NEW LED LIGHTING. APPEAR WITHIN ONE (1) YEAR AFTER THE COMPLETION AND ACCEPTANCE OF THE PLUMBING - REPLACING PLUMBING FIXTURES AND CONNECTIONS WORK UNDER THIS CONTRACT. IN EXISTING RESTROOMS AND LAUNDRY ROOM 14. CONTRACTOR TO PROVIDE BACKING OR BLOCKING AS REQUIRED FOR MOUNTING ALL WALL MOUNTED SHELVES, EQUIPMENT, ACCESSORIES, CABINETS, ETC. 15. CONTRACTOR TO PROTECT ALL TREES AND ROOTS NOT SLATED FOR REMOVAL DURING CONSTRUCTION. 16. GENERAL CONTRACTOR RESPONSIBLE FOR MAINTENANCE OF STAGING AREA AND TO SEPARATE PERMITS AND DEFERRED SUBMITTAL ENSURE THAT MATERIALS DELIVERY AND STORAGE DOES NOT INTERFERE WITH DAILY OPERATION OF ADJACENT PROPERTIES OR PUBLIC RIGHT OF WAY. **BIDDER DESIGN ITEMS** 17. GENERAL CONTRACTOR RESPONSIBLE FOR CONSTRUCTION STAKING. CONTRACTOR SHALL PROVIDE DESIGN, ENGINEERING, FURNISHING AND INSTALLATION OF A COMPLETE, FUNCTIONING SYSTEM(S) BASED ON THE SCHEMATIC LAYOUT SHOWN ON THE ARCHITECTURAL DRAWINGS, DESCRIBED HEREIN AND IN COMPLIANCE WITH PREVAILING CODE. THE CONTRACTOR SHALL BE RESPONSIBLE FOR FINAL ORDERING OF ALL DEVICES AND FIXTURES TO ENSURE PROPER OPTIONS, ACCESSORIES AND CONFIGURATIONS. CONTRACTOR SHALL PROVIDE COMPLETE DESIGN AND DOCUMENTATION AS REQUIRED FOR SUBMISSION TO, AND APPROVAL OF ARCHITECT, OWNER, AND GOVERNING BUILDING DEPARTMENT. UPON COMPLETION OF REVIEW BY THE ARCHITECT OR ENGINEER OF RECORD, THE CONTRACTOR SHALL BE RESPONSIBLE FOR ROUTING DOCUMENTS TO PERMIT AGENCY FOR PLANS REVIEW AND PAYING ANY PLANS CHECK AND PERMIT FEES. **DELEGATED / BIDDER DESIGN ITEMS:** 1. MECHANICAL, ELECTRICAL AND PLUMBING SYSTEMS FIRE DETECTION THE FOLLOWING DELEGATED ITEMS REQUIRE A DEFERRED SUBMITTAL TO JURISDICTION: 1. FIRE DEPARTMENT ACCESS KEY BOX 2. HANGERS AND SUPPORT FOR HVAC 3. VIBRATION AND SEISMIC CONTROLS FOR HVAC 4. LATERAL BRACING AND ANCHORAGE OF MECHANICAL AND ELECTRICAL EQUIPMENT WEIGHING MORE THAN 75 LBS (EXCEPTIONS PER ASCE 7, SECTION 13.1.4) SEE SPECIFICATIONS AND/OR DESIGN NARRATIVE FOR ADDITIONAL REQUIREMENTS NOT LISTED HERE AND ADDITIONAL BIDDER DESIGN ITEMS. **ALTERNATES** IN ADDITION TO THE BASE BUILDING BID, THE CONTRACTOR SHALL PROVIDE THE FOLLOWING SEE ARCHITECTURAL DRAWINGS AND PROJECT MANUAL FOR ADDITIONAL SCOPE OF ALTERNATES. . REBUILD STAIRS TO 2ND FLOOR 2. LAUNDRY ROOM 113 (LOCKER ROOM) A. PROVIDE POWER, WATER, TRAP PRIMER, AND VENT FOR WASHER AND DRYER B. ROOM VENTILATION FOR LAUNDRY EQUIPMENT C. NEW CASEWORK ABOVE LAUNDRY D. NEW CASEWORK ON WALL OPPSITE LAUNDRY EQUIPMENT E. NEW FLOOR DRAIN IN FRONT OF WASHER 3. NEW CASEWORK IN APPARATAS BAY 4. NEW CASEWORK NEXT TO FRIDGE IN DINING AREA (BELOW WINDOW) **VICINITY MAP**



2525 E Burnside St. Portland, OR 97214

SIDNEY I SCOTT
PORTLAND, OREGON

503.226.3617

seallp.com

#24115

Digitally signed by Sid Scott
Date: 2025.01.06 16:36:25-08'00'

Clackamas Fire

District:
Station 12
Job Number:

18081 S Harding Rd

Oregon City, OR 97045



BID SET
PERMIT SET

SSUE

Drawing:

GENERAL PROJECT INFORMATION

01.06.25


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	B - FIRE STATION,									
CHARTER 4: SDE		REMENTS BASED ON OCCUPANC	Y AND LISE	CHAPTER 10: ME	ANS OF EGRESS					
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SECTION 420.2	SEPARATING SLEEPING UNI	LING UNITS IN THE SAME BUILDING, SLEEP ITS FROM OTHER OCCUPANCIES CONTING RTITIONS IN ACCORDANCE WITH SECTION	SUOUS TO THEM IN THE SAME BUILDING SHALL BE	SECTION 1004 SECTION 1005.3.1 SECTION 1005.3.2	OCCUPANT LOAD (OL) STAIRWAY EGRESS CAPACIT OTHER EGRESS CAPACITY FA					
SECTION 420.3		TINGUOUS TO THEM IN THE SAME BUILDIN	DING AND SEPARATING SLEEPING UNITS FROM IG SHALL BE CONSTRUCTED AS HORIZONTAL	TABLE 1006.2.1	SPACES WITH ONE EXIT OR E MAX OCCUPANT LOAD MAX COMMON PATH OF E	EXIT ACCESS DOORW		FT		
SECTION 420.4 SECTION 420.5		NOT HAVE A FIRE ALARM SYSTEM. SMOKE	TEM. NO CHANGE OF OCCUPANCY IS PROPOSED. DETECTORS WILL BE PROVIDED IN EACH	TABLE 1006.3.3	MINIMUM NUMBER OF EXITS OCCUPANT LOAD PER STO	OR ACCESS TO EXITS	OL > 30: 75 FT S PER STORY 500			
CUADTED 5. CE	NERAL BUILDING HEIGH	TO AND ADEAC		TABLE 1006.3.4(1)	STORIES WITH ONE EXIT FOR		OT APPLICABLE			
TABLE 504.3	ALLOWABLE HEIGHT / STOR			TABLE 1006.3.4(2)	STORIES WITH ONE EXIT FOR					
TABLE 504.4 TABLE 506.2	AREA FACTOR				FIRST STORY ABOVE/BELOV SECOND STORY ABOVE GR THIRD STORY AND HIGHER	ADE PLANE	49 / 75 FT 29 / 75 FT NOT PERMITTED)		
MODIFICATIONS				SECTION 1009.1 SECTION 1009.2.1	NUMBER OF ACCESSIBLE ME			OLUBED.		
SECTION 506.2.1 Single Occupancy	BUILDING AREA	Aa = At + (NS x lf) = 9000 SF + (0 SF x 0)		SECTION 1009.3.2	ACCESSIBLE STAIRWAY WIDT		NOT REC	R 1011.2		
		= 9000 SF PÈR STORY		SECTION 1009.3.3 SECTION 1011.2	AREA OF REFUGE MINIMUM STAIR WIDTH		NOT REC	JUIRED		
				TABLE 1017.2	EXIT ACCESS TRAVEL DISTAN	NCF	200 FT			
SECTION 506.3	FRONTAGE INCREASE	1 LF / 1 LF		TABLE 1017.2	CORRIDOR FIRE-RESISTANCE		200 F I B = 1 HR			
TABLE 506.3.3		= 100 % FRONTAGE > 20' Width = 20 FT If = 0	FRONTAGE INCREASE NOT USED	TABLE 1020.2	MINIMUM CORRIDOR WIDTH	_ IVATING	44 INCHES			
TABLE 500.3.3	ACTUAL HEIGHT / STORIES	18' - 0" / 2 STORY	FRONTAGE INCREASE NOT USED	SECTION 1020.5	DEAD ENDS	20) FEET			
	LARGEST INDIVIDUAL STOR' ACTUAL BUILDING AREA	Y 3840 SF 5300 SF		SEG1161V 1020.0	*LENGTH IS NOT LIMITED WH					
MIXED OCCUPANCY SECTION 508.2	ACCESSORY	N/A		CHAPTER 11: AC	CESSIBILITY					
SECTION 508.3	NON-SEPARATED	N/A		APPLICABLE CODES						
SECTION 508.4	SEPARATED	N/A			ANSI ICC A117.1 - 2017					
SECTION 509 CHAPTER 6: TYP	INCIDENTAL USE PES OF CONSTRUCTION	PER TABLE 509.1								
TABLE 601	EIDE DESISTANCE DATING E			_						
	TINE NESISTANCE NATING I	REQUIREMENTS FOR BUILDING ELEMENTS								
	PRIMARY STRUCTURAL FR BEARING WALLS EXTERIOR INTERIOR NON BEARING WALLS AND NON BEARING WALLS AND FLOOR CONSTRUCTION AN	BUILDING ELEMENT RAME D PARTITIONS - EXTERIOR D PARTITIONS - INTERIOR ND SECONDARY MEMBERS	FIRE RATING * 0 HOUR 0 HOUR 0 HOUR PER TABLE 705.5 0 HOUR 0 HOUR 0 HOUR							
CHAPTER 7: FIR	PRIMARY STRUCTURAL FR BEARING WALLS EXTERIOR INTERIOR NON BEARING WALLS AND NON BEARING WALLS AND FLOOR CONSTRUCTION AN ROOF CONSTRUCTION AN	BUILDING ELEMENT RAME PARTITIONS - EXTERIOR PARTITIONS - INTERIOR ND SECONDARY MEMBERS D SECONDARY MEMBERS SISTANCE RATING REQUIRED BY OTHER S	FIRE RATING * 0 HOUR 0 HOUR 0 HOUR PER TABLE 705.5 0 HOUR 0 HOUR 0 HOUR	CHARTER 20: DI	IMDING FIVTURES					
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CHAPTER 7: FIRE TABLE 705.2 TABLE 705.5	PRIMARY STRUCTURAL FREE BEARING WALLS EXTERIOR INTERIOR NON BEARING WALLS AND NON BEARING WALLS AND FLOOR CONSTRUCTION AND ROOF CONSTRUCTION AND * NOT LESS THAN FIRE-RESERVENCE OF PROPERTY MINIMUM DISTANCE OF PROPERTY AND STRUCTION OF PROPERTY AND SMOKE PROTECT	BUILDING ELEMENT RAME D PARTITIONS - EXTERIOR D PARTITIONS - INTERIOR ND SECONDARY MEMBERS ID SECONDARY MEMBERS ESISTANCE RATING REQUIRED BY OTHER SECONDARY FION FEATURES OJECTION PER TABLE 705.2 REQUIREMENTS FOR EXTERIOR WALLS BACK THE RATING 1 HOUR	FIRE RATING * 0 HOUR 0 HOUR PER TABLE 705.5 0 HOUR 0 HOUR 0 HOUR SECTIONS OF THIS CODE	CHAPTER 29: PLU FUNCTION (CH. 10) B	JMBING FIXTURES OCCUPANTS TOTAL MALE 61 31		E SUMMARY WATER CLOSETS MALE FEMALE		TORIES FEMALE	DRINKING
TABLE 705.2	PRIMARY STRUCTURAL FREE BEARING WALLS EXTERIOR INTERIOR NON BEARING WALLS AND NON BEARING WALLS AND FLOOR CONSTRUCTION AN ROOF CONSTRUCTION AN * NOT LESS THAN FIRE-RESERVED THE RESISTANCE RATING IF FIRE SEPARATION DISTANCE X < 5' 5' <= X < 10' 10' <= X < 30'	BUILDING ELEMENT RAME PARTITIONS - EXTERIOR PARTITIONS - INTERIOR D PARTITIONS - INTERIOR ND SECONDARY MEMBERS D SECONDARY MEMBERS SISTANCE RATING REQUIRED BY OTHER S TION FEATURES OJECTION PER TABLE 705.2 REQUIREMENTS FOR EXTERIOR WALLS BACE FIRE RATING 1 HOUR 1 HOUR 0 HOUR	FIRE RATING * 0 HOUR 0 HOUR PER TABLE 705.5 0 HOUR 0 HOUR 0 HOUR SECTIONS OF THIS CODE	FUNCTION (CH. 10) B REQUIRED	OCCUPANTS TOTAL MALE 61 31	FEMALE	WATER CLOSETS MALE FEMALE 2 2		FEMALE 1	FOUNTAIN 0
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TABLE 705.2 TABLE 705.5 TABLE 706.4 SECTION 708 SECTION 709 SECTION 711 711.2.4.1 711.2.4.2 711.2.4.3 711.2.4.4 711.2.4.5 711.2.4.6	PRIMARY STRUCTURAL FR BEARING WALLS EXTERIOR INTERIOR NON BEARING WALLS AND NON BEARING WALLS AND FLOOR CONSTRUCTION AN ROOF CONSTRUCTION AN * NOT LESS THAN FIRE-RE: PIRE RESISTANCE RATING I FIRE RESISTANCE RATING I FIRE SEPARATION DISTANC X < 5' 5' <= X < 10' 10' <= X < 30' X >= 30' FIRE WALL FIRE RESISTANC FIRE PARTITIONS SMOKE BARRIERS FLOOR AND ROOF ASSEMB SEPARATING MIXED OF SEPARATING FIRE ARE DWELLING / SLEEPING SEPARATING SMOKE O SEPARATING INCIDENT OTHER SEPARATIONS	BUILDING ELEMENT RAME D PARTITIONS - EXTERIOR D PARTITIONS - INTERIOR ND SECONDARY MEMBERS D SECONDARY MEMBERS SISTANCE RATING REQUIRED BY OTHER S CION FEATURES DJECTION PER TABLE 705.2 REQUIREMENTS FOR EXTERIOR WALLS BACE FIRE RATING 1 HOUR 1 HOUR 0 HOUR 0 HOUR 1 HOUR CE 0 HOUR 1 HOUR SLEEPING UNIT SE NOT REQUIRED BLIES (SUPPORTING CONSTRUCTION PER 7) CCUPANCIES PER SECTION 508.4 EAS NA G UNITS 1 HOUR COMPARTMENTS NA TAL USES NA	FIRE RATING * 0 HOUR 0 HOUR PER TABLE 705.5 0 HOUR 0 HOUR 0 HOUR SECTIONS OF THIS CODE SECTIONS ON FIRE SEPARATION DISTANCE	FUNCTION (CH. 10) B REQUIRED	TOTAL MALE 61 31 FIXTURES PROVIDED	FEMALE 31	WATER CLOSETS MALE FEMALE 2 2 2	MALE 1	FEMALE 1 2	FOUNTAIN 0 0
TABLE 705.2 TABLE 705.5 TABLE 706.4 SECTION 708 SECTION 709 SECTION 711 711.2.4.1 711.2.4.2 711.2.4.3 711.2.4.4 711.2.4.5	PRIMARY STRUCTURAL FREDRING WALLS EXTERIOR INTERIOR NON BEARING WALLS AND NON BEARING WALLS AND FLOOR CONSTRUCTION AN * NOT LESS THAN FIRE-REI MINIMUM DISTANCE OF PRO FIRE RESISTANCE RATING IN FIRE SEPARATION DISTANCE X < 5' 5' <= X < 10' 10' <= X < 30' X >= 30' FIRE WALL FIRE RESISTANCE FIRE PARTITIONS SMOKE BARRIERS FLOOR AND ROOF ASSEMB SEPARATING MIXED OF SEPARATING FIRE ARE DWELLING / SLEEPING SEPARATING INCIDENT OTHER SEPARATIONS TERIOR FINISHES	BUILDING ELEMENT RAME D PARTITIONS - EXTERIOR D PARTITIONS - INTERIOR ND SECONDARY MEMBERS D SECONDARY MEMBERS SISTANCE RATING REQUIRED BY OTHER S CION FEATURES DJECTION PER TABLE 705.2 REQUIREMENTS FOR EXTERIOR WALLS BACE FIRE RATING 1 HOUR 1 HOUR 0 HOUR 0 HOUR 1 HOUR CE 0 HOUR 1 HOUR SLEEPING UNIT SE NOT REQUIRED BLIES (SUPPORTING CONSTRUCTION PER 7) CCUPANCIES PER SECTION 508.4 EAS NA G UNITS 1 HOUR COMPARTMENTS NA TAL USES NA	FIRE RATING * 0 HOUR 0 HOUR PER TABLE 705.5 0 HOUR 0 HOUR 0 HOUR SECTIONS OF THIS CODE SECTIONS OF THIS CODE SECTIONS PERARATION PERARATION PARATION PARATION PARATION PARATING)	REQUIRED GENDER NEUTRAL	TOTAL MALE 61 31 FIXTURES PROVIDED	FEMALE 31 *2 EXIS	WATER CLOSETS MALE FEMALE 2 2 STING UNISEX RESTRO	MALE 1	FEMALE 1 2	FOUNTAIN 0 0
TABLE 705.2 TABLE 705.5 TABLE 706.4 SECTION 708 SECTION 709 SECTION 711 711.2.4.1 711.2.4.2 711.2.4.3 711.2.4.4 711.2.4.5 711.2.4.6 CHAPTER 8: INT	PRIMARY STRUCTURAL FR BEARING WALLS EXTERIOR INTERIOR NON BEARING WALLS AND NON BEARING WALLS AND FLOOR CONSTRUCTION AN ROOF CONSTRUCTION AN * NOT LESS THAN FIRE-RE- RE AND SMOKE PROTECT MINIMUM DISTANCE OF PRO FIRE RESISTANCE RATING I FIRE SEPARATION DISTANC X < 5' 5' <= X < 10' 10' <= X < 30' X >= 30' FIRE WALL FIRE RESISTANC FIRE PARTITIONS SMOKE BARRIERS FLOOR AND ROOF ASSEMB SEPARATING MIXED OF SEPARATING FIRE ARE DWELLING / SLEEPING SEPARATING SMOKE OF SEPARATING INCIDENT OTHER SEPARATIONS TERIOR FINISHES INTERIOR WALL AND CEILING INTERIOR EXIT STAIRWAYS CORRIDORS AND ENCLOSURE	BUILDING ELEMENT RAME D PARTITIONS - EXTERIOR D PARTITIONS - INTERIOR ND SECONDARY MEMBERS D SECONDARY MEMBERS SISTANCE RATING REQUIRED BY OTHER SECONDARY MEMBERS OJECTION PER TABLE 705.2 REQUIREMENTS FOR EXTERIOR WALLS BACE FIRE RATING 1 HOUR 1 HOUR 0 HOUR 1 HOUR CE 0 HOUR 1 HOUR SLEEPING UNIT SECONDARD WALLS BACE FOR SECTION 508.4 EAS NA SUNITS 1 HOUR COMPARTMENTS NA TAL USES NA NA TAL USES NA NA OG FINISH REQUIREMENTS (FLAME SPREAD AND RAMPS AND EXIT PASSAGEWAYS RES FOR EXIT ACCESS STAIRWAYS AND RE	FIRE RATING * 0 HOUR 0 HOUR 0 HOUR PER TABLE 705.5 0 HOUR 0 HOUR 0 HOUR SECTIONS OF THIS CODE PARATION PARATING) PARATING)	FUNCTION (CH. 10) B REQUIRED GENDER NEUTRAL I CHAPTER 34: EXI SECTION 3403.6 AND CONTRACTOR IN THE PROPERTY OF ALTER	TOTAL MALE 61 31 FIXTURES PROVIDED STING BUILDINGS DRS 447.241: ACCESSIBILITY FOR	*2 EXISTING BUILDING	WATER CLOSETS MALE FEMALE 2 2 2 STING UNISEX RESTRO SS = \$112,500	1 DOMS WITH 1 WC,	FEMALE 1 2	FOUNTAIN 0 0
TABLE 705.2 TABLE 705.5 TABLE 706.4 SECTION 708 SECTION 711 711.2.4.1 711.2.4.2 711.2.4.3 711.2.4.4 711.2.4.5 711.2.4.6 CHAPTER 8: INT	PRIMARY STRUCTURAL FREDEARING WALLS EXTERIOR INTERIOR NON BEARING WALLS AND NON BEARING WALLS AND FLOOR CONSTRUCTION AN ROOF CONSTRUCTION AN * NOT LESS THAN FIRE-RES RE AND SMOKE PROTECT MINIMUM DISTANCE OF PRO FIRE RESISTANCE RATING I FIRE SEPARATION DISTANC X < 5' 5' <= X < 10' 10' <= X < 30' X >= 30' FIRE WALL FIRE RESISTANC FIRE PARTITIONS SMOKE BARRIERS FLOOR AND ROOF ASSEMB SEPARATING MIXED OF SEPARATING FIRE ARE DWELLING / SLEEPING SEPARATING INCIDENT OTHER SEPARATIONS TERIOR FINISHES INTERIOR WALL AND CEILIN INTERIOR EXIT STAIRWAYS CORRIDORS AND ENCLOSED SPARATIONS INTERIOR EXIT STAIRWAYS CORRIDORS AND ENCLOSED SPARATIONS ROOMS AND ENCLOSED SPARATIONS	BUILDING ELEMENT RAME D PARTITIONS - EXTERIOR D PARTITIONS - INTERIOR ND SECONDARY MEMBERS D SECONDARY MEMBERS SISTANCE RATING REQUIRED BY OTHER SECONDARY MEMBERS OJECTION PER TABLE 705.2 REQUIREMENTS FOR EXTERIOR WALLS BASE THOUR T	FIRE RATING * 0 HOUR 0 HOUR 1 HOUR 1 HOUR 1 HOUR 1 HOUR 1 HOUR 2 HOUR 3 HOUR SECTIONS OF THIS CODE PARATION PARATION PARATION PARATION PARATION PARATION PARATING) B A	FUNCTION (CH. 10) B REQUIRED GENDER NEUTRAL I SECTION 3403.6 AND CONTROL OF ALTER COSTS OF ACCESSIBILE ELEMENT	OCCUPANTS TOTAL MALE 61 31 FIXTURES PROVIDED STING BUILDINGS DRS 447.241: ACCESSIBILITY FOR ATIONS: \$450,000 LITY IMPROVEMENTS NEED NOT	*2 EXISTING BUILDING \$ x .25 EXCEED 25% OF ALT EXISTING	WATER CLOSETS MALE FEMALE 2 2 STING UNISEX RESTRO S = \$112,500 ERATIONS PER 3403.6. PROPO	7.1 EX. 1	1 2 1 LAV, AND 1 SH	O O O O O O O O O O O O O O O O O O O
TABLE 705.2 TABLE 705.5 TABLE 706.4 SECTION 708 SECTION 711 711.2.4.1 711.2.4.2 711.2.4.3 711.2.4.4 711.2.4.5 711.2.4.6 CHAPTER 8: INT	PRIMARY STRUCTURAL FREDEARING WALLS EXTERIOR INTERIOR NON BEARING WALLS AND NON BEARING WALLS AND FLOOR CONSTRUCTION AN ROOF CONSTRUCTION AN * NOT LESS THAN FIRE-RE RE AND SMOKE PROTECT MINIMUM DISTANCE OF PRO FIRE RESISTANCE RATING I FIRE SEPARATION DISTANCE X < 5' 5' <= X < 10' 10' <= X < 30' X >= 30' FIRE WALL FIRE RESISTANCE FIRE PARTITIONS SMOKE BARRIERS FLOOR AND ROOF ASSEMB SEPARATING MIXED OF SEPARATING SEPARATIONS SEPARATING SMOKE OF SEPARATING SHOKE OF SEPARATIONS TERIOR FINISHES INTERIOR WALL AND CEILIN INTERIOR EXIT STAIRWAYS CORRIDORS AND ENCLOSED ROOMS AND ENCLOSED SPO	BUILDING ELEMENT RAME D PARTITIONS - EXTERIOR D PARTITIONS - INTERIOR D SECONDARY MEMBERS D SECONDARY MEMBERS D SECONDARY MEMBERS SISTANCE RATING REQUIRED BY OTHER SECONDARY MEMBERS OJECTION PER TABLE 705.2 REQUIREMENTS FOR EXTERIOR WALLS BACE FIRE RATING 1 HOUR 1 HOUR 0 HOUR 0 HOUR CE 0 HOUR 1 HOUR SLEEPING UNIT SECONDARD SECONDAR	FIRE RATING * 0 HOUR 0 HOUR 0 HOUR PER TABLE 705.5 0 HOUR 0 HOUR 0 HOUR SECTIONS OF THIS CODE PARATION PARATING) PARATING)	FUNCTION (CH. 10) B REQUIRED GENDER NEUTRAL I SECTION 3403.6 AND CONTROL OF ALTER COSTS OF ACCESSIBILE ELEMENT (a) PARKING (b) ENTRANCE (c) ACCESSIBLE ROUTE	OCCUPANTS TOTAL MALE 61 31 FIXTURES PROVIDED STING BUILDINGS DRS 447.241: ACCESSIBILITY FOR ATIONS: \$450,000 LITY IMPROVEMENTS NEED NOT	*2 EXISTING BUILDING \$ x .25 EXCEED 25% OF ALT EXISTING NON-COMPLIANT NON-COMPLIANT NON-COMPLIANT	WATER CLOSETS MALE FEMALE 2 2 STING UNISEX RESTRO ERATIONS PER 3403.6. PROPO COMPI COMPI COMPI COMPI COMPI	7.1 EX. 1 OSED LIANT LIANT	1 2 1 LAV, AND 1 SH	OJECTED COS \$3,00 \$2,00 \$20,00
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		LIFE SAFETY OCCUPANT L		
		TABLE 1	004.5	
AREA NAME	AREA (SF)	FUNCTION OF SPACE	OCCUPANT LOAD FACTOR	OCCUPANT LOAD
FIRST FLOOR				
APPARATUS BAY	1881 SF	Garage	200	10
DORM 1	114 SF	Dormitories	50	3
DORM 2	144 SF	Dormitories	50	3
DORM 3	144 SF*	Dormitorie s	50	3
KITCHEN/LIVING	558 SF	Dormitories	50	12
LAUNDRY	95 SF	Accessory	300	1
LOBBY	102 SF	Business	150	1
OFFICE SUITE EXAMPLE	395 SF	Business	100	4
RR	43 SF	Residential	200	1
RR	88 SF	Residential	200	1
STORAGE	164 SF	Storage	300	1
STORAGE	14 SF	Storage	300	1
TURN OUT	71 SF	Storage	300	1
SECOND FLOOR				42
FITNESS	687 SF	Exercise	50	14
LOUNGE	679 SF	Business	150	5
-				19

*THOUGH THE OCCUPANT LOAD SCHEDULE CITES 61 TOTAL OCCUPANTS IT WAS NOTED BY CLACKAMAS FIRE DISTRICT THAT THERE WILL BE 2 FIRE FIGHTERS OCCUPYING THE STATION AT A GIVEN TIME DURING A SHIFT CYCLE WHEN FULLY OPERATIONAL. THERE IS A THIRD 'FUTURE DORM' INCLUDED IN THIS RENOVATION SO THE ACTUAL NUMBER OF OCCUPANTS IS 3 MAXIMUM DURING A SHIFT.

*303.1.2 SMALL ASSEMBLY SPACES ROOM OR SPACE USED FOR ASSEMBLY PURPOSES THAT IS LESS THAN 750 SQUARE FEET IN AREA AND ACCESSORY TO ANOTHER OCCUPANCY SHALL BE CLASSIFIED AS A GROUP B OCCUPANCY OR AS PART OF THAT OCCUPANCY.

	EXIT DOOR SUMMARY											
EXIT#	OCCUPANT LOAD	REQUIRED CLEAR WIDTH (*.2)	REQUIRED CLEAR WIDTH (*.15)	DOOR WIDTH	CLEAR WIDTH PROVIDED							
Α				36"	32"							
В				36"	32"							

EXIT ACCESS	TRAVEL DISTANCE
EGRESS PATH NAME	EGRESS PATH LENGTH
PATH A	86' - 7"
PATH B	78' - 0"

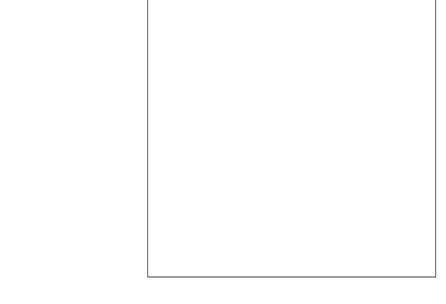CODE SUMMARY LEGEND

1 HOUR FIRE PARTITION

WALL RATINGS TO CONTINUE ABOVE / BELOW ALL DOORS, RELITES, ETC.

- AREA NAME

- AREA (SF)

TOTALS EXIT SIGN

-PATH A 100' - 0"

— OCCUPANCY (CH. 3)

FUNCTION (CH. 10)

UNOCCUPIED AREA.

EXIT ACCESS PATH

EXIT /EXIT ACCESS

OCCUPANT LOAD NOT INCLUDED IN BUILDING

SHADE INDICATES ILLUMINATED FACE. CHEVRON INDICATES DIRECTION TO EXIT

DOOR RATING (IN MINUTES)


FIRE EXTINGUISHER (FE) LOCATION - ALL ARE EXISTING -NONE PROPOSED. VERIFY EXACT LOCATIONS AND QUANTITY WITH FIRE

DEPARTMENT.


NOT CALCULATED AS OCCUPIABLE SPACE

(SEE PHOTO BELOW)


— OCCUPANT LOAD FACTOR / NUMBER OF OCCUPANTS

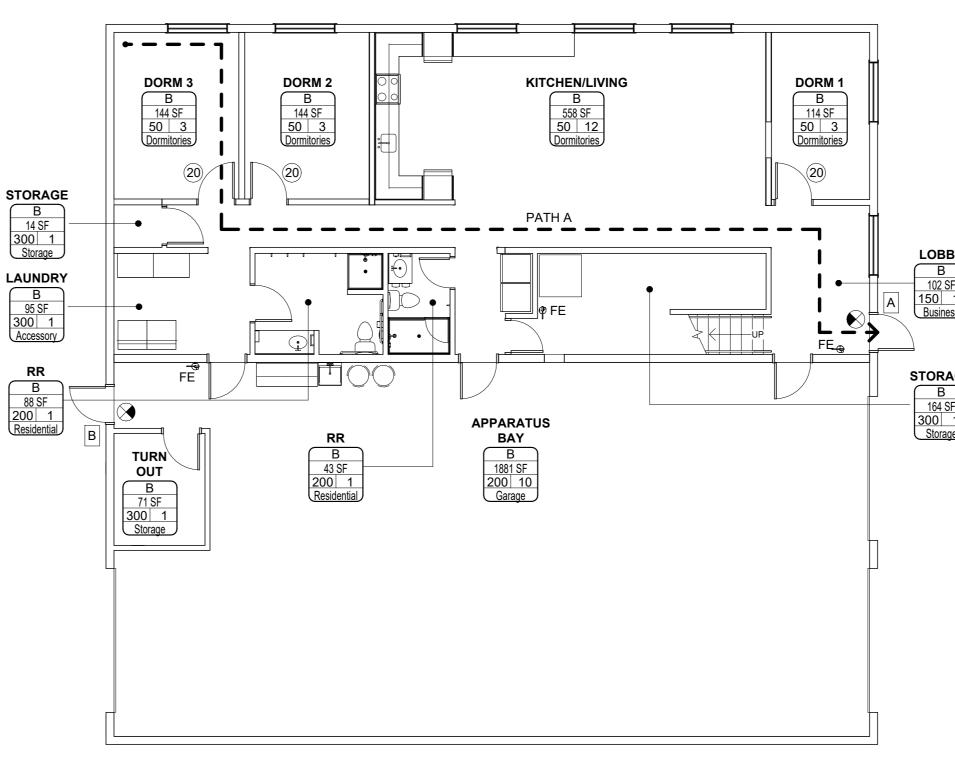

1	FIRST FLOOR LIFE SAFETY PLAN
	1/8" = 1'-0"

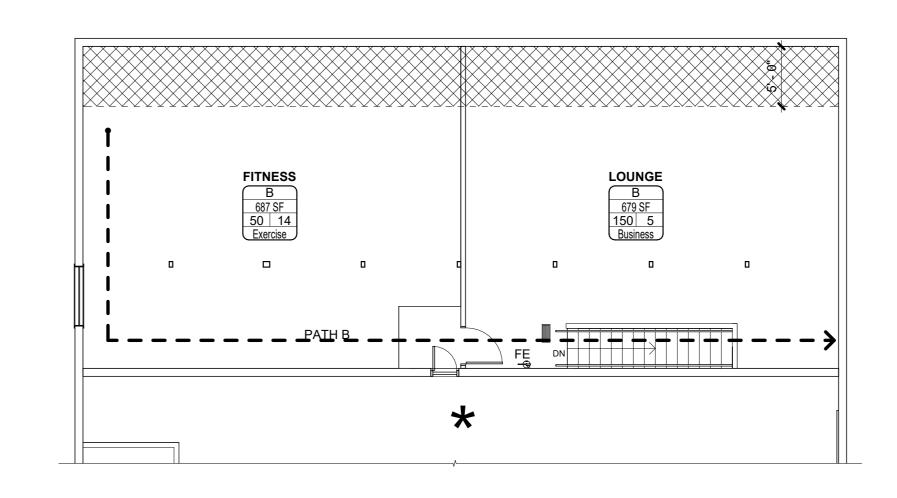



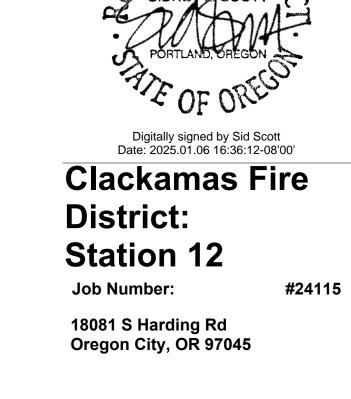

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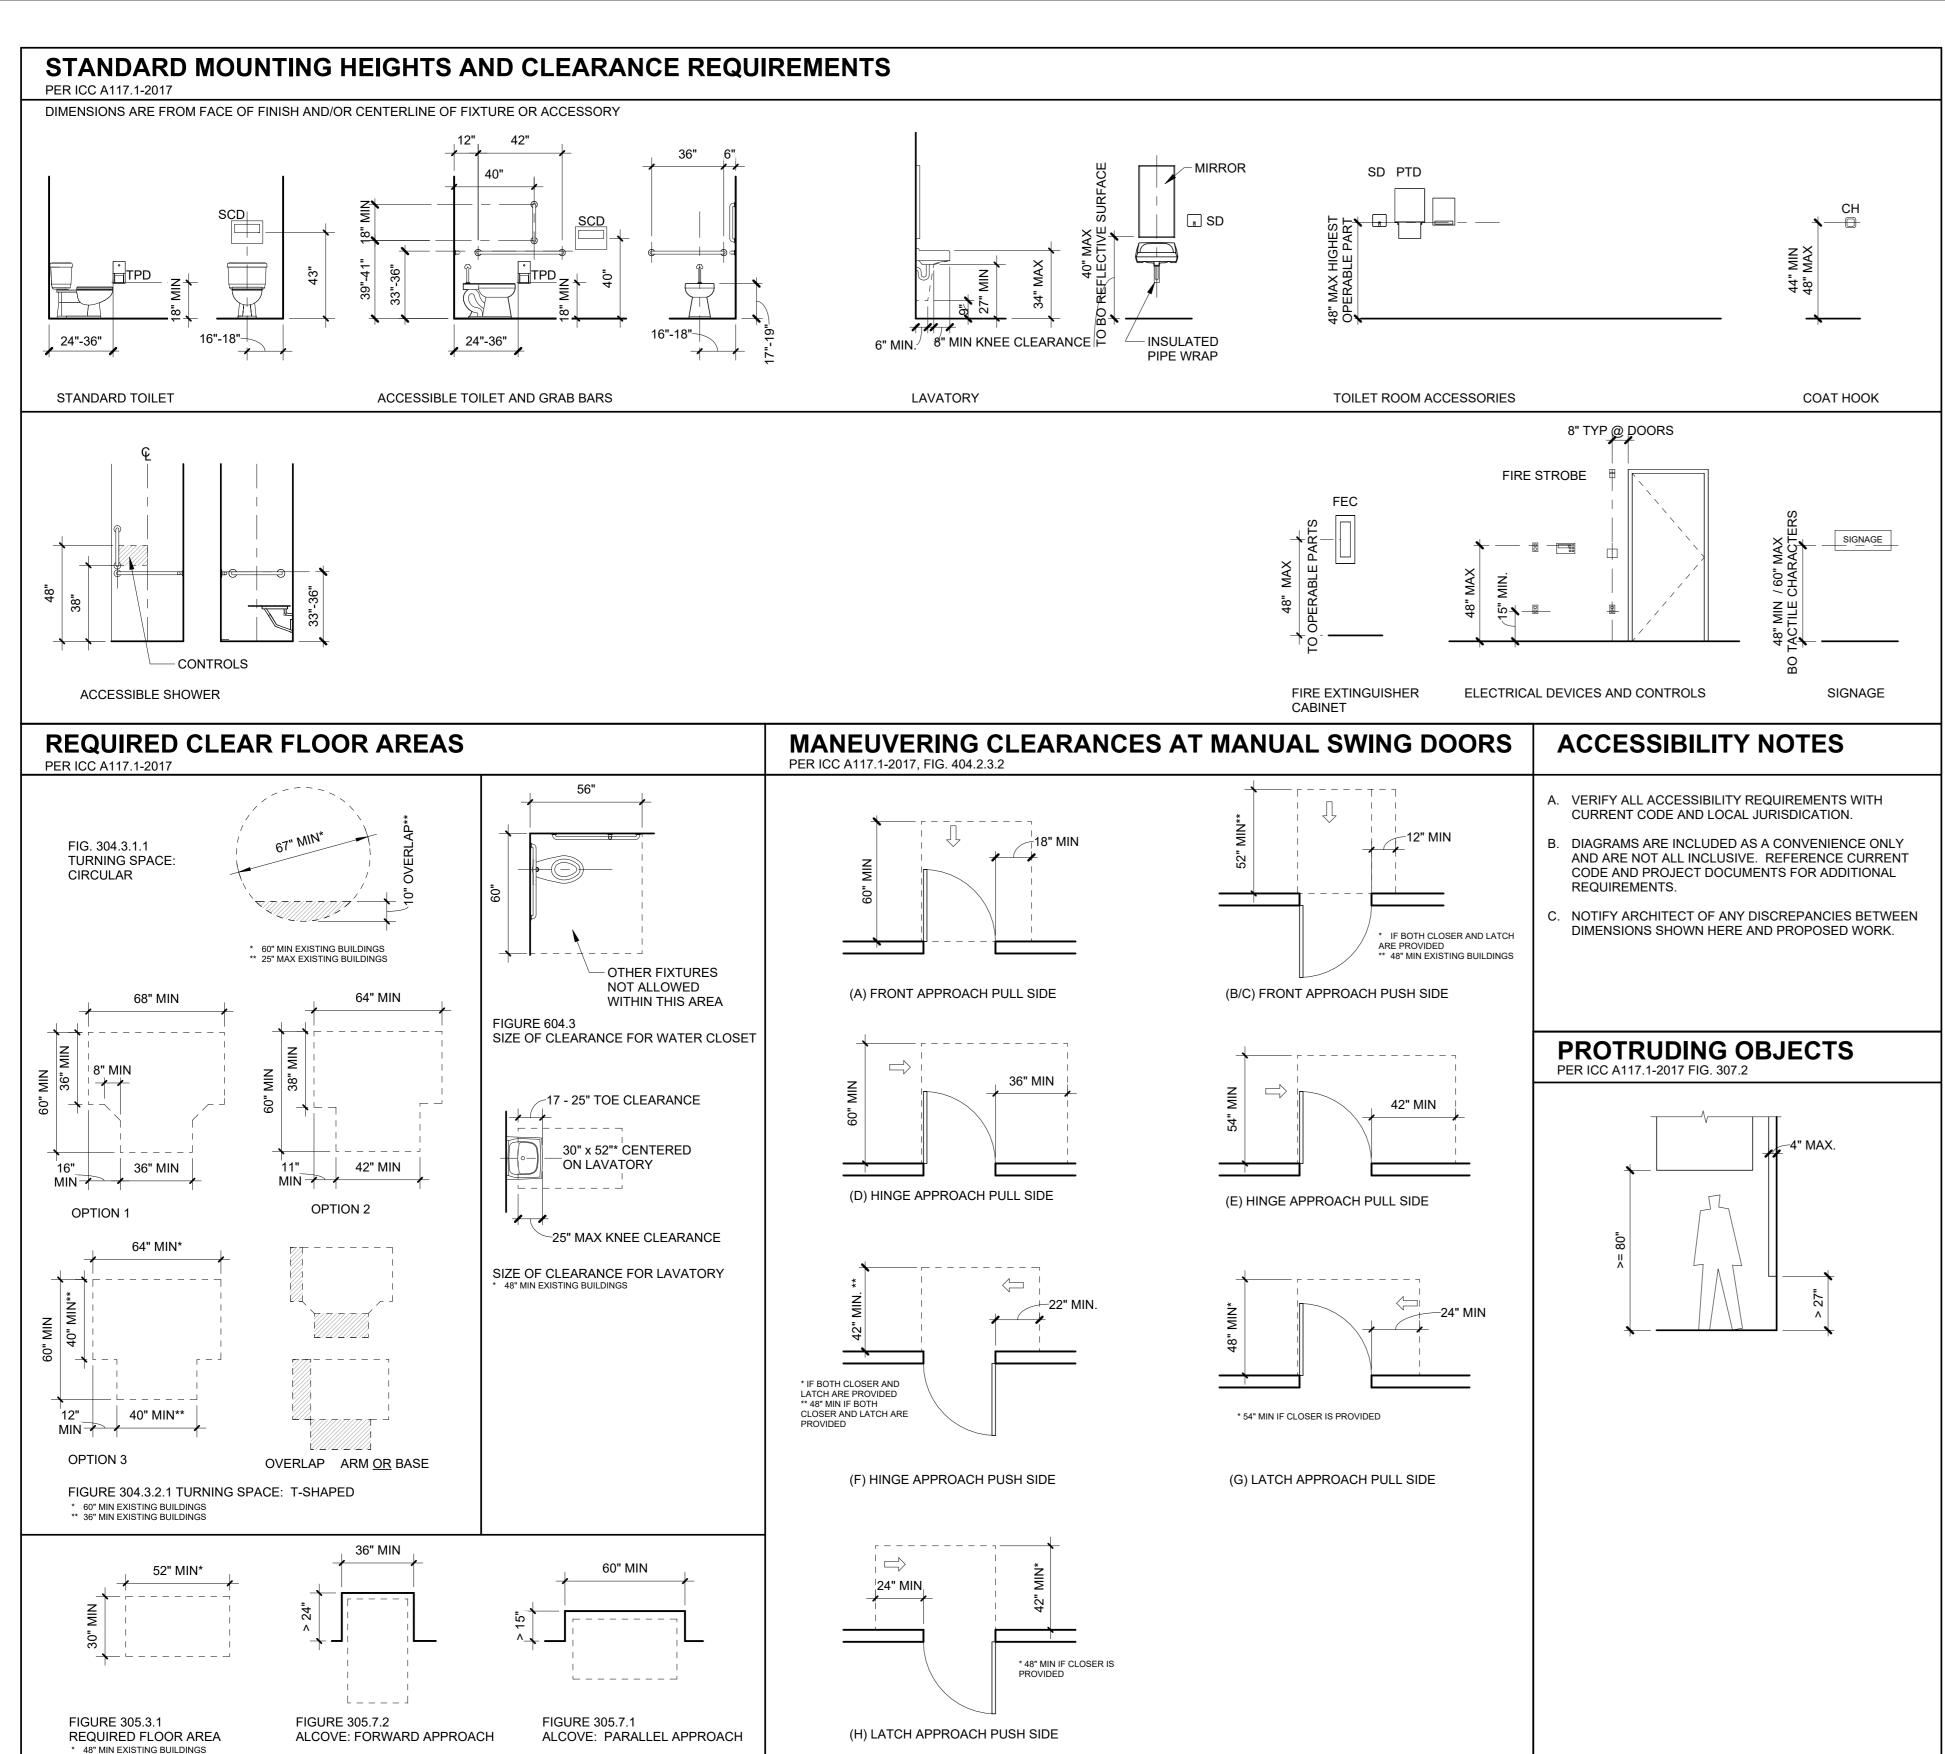






BID SET 01.06.25 PERMIT SET 12.20.24 ISSUE DATE Drawing:

CODE SUMMARY & FIRE LIFE SAFETY

G1.01



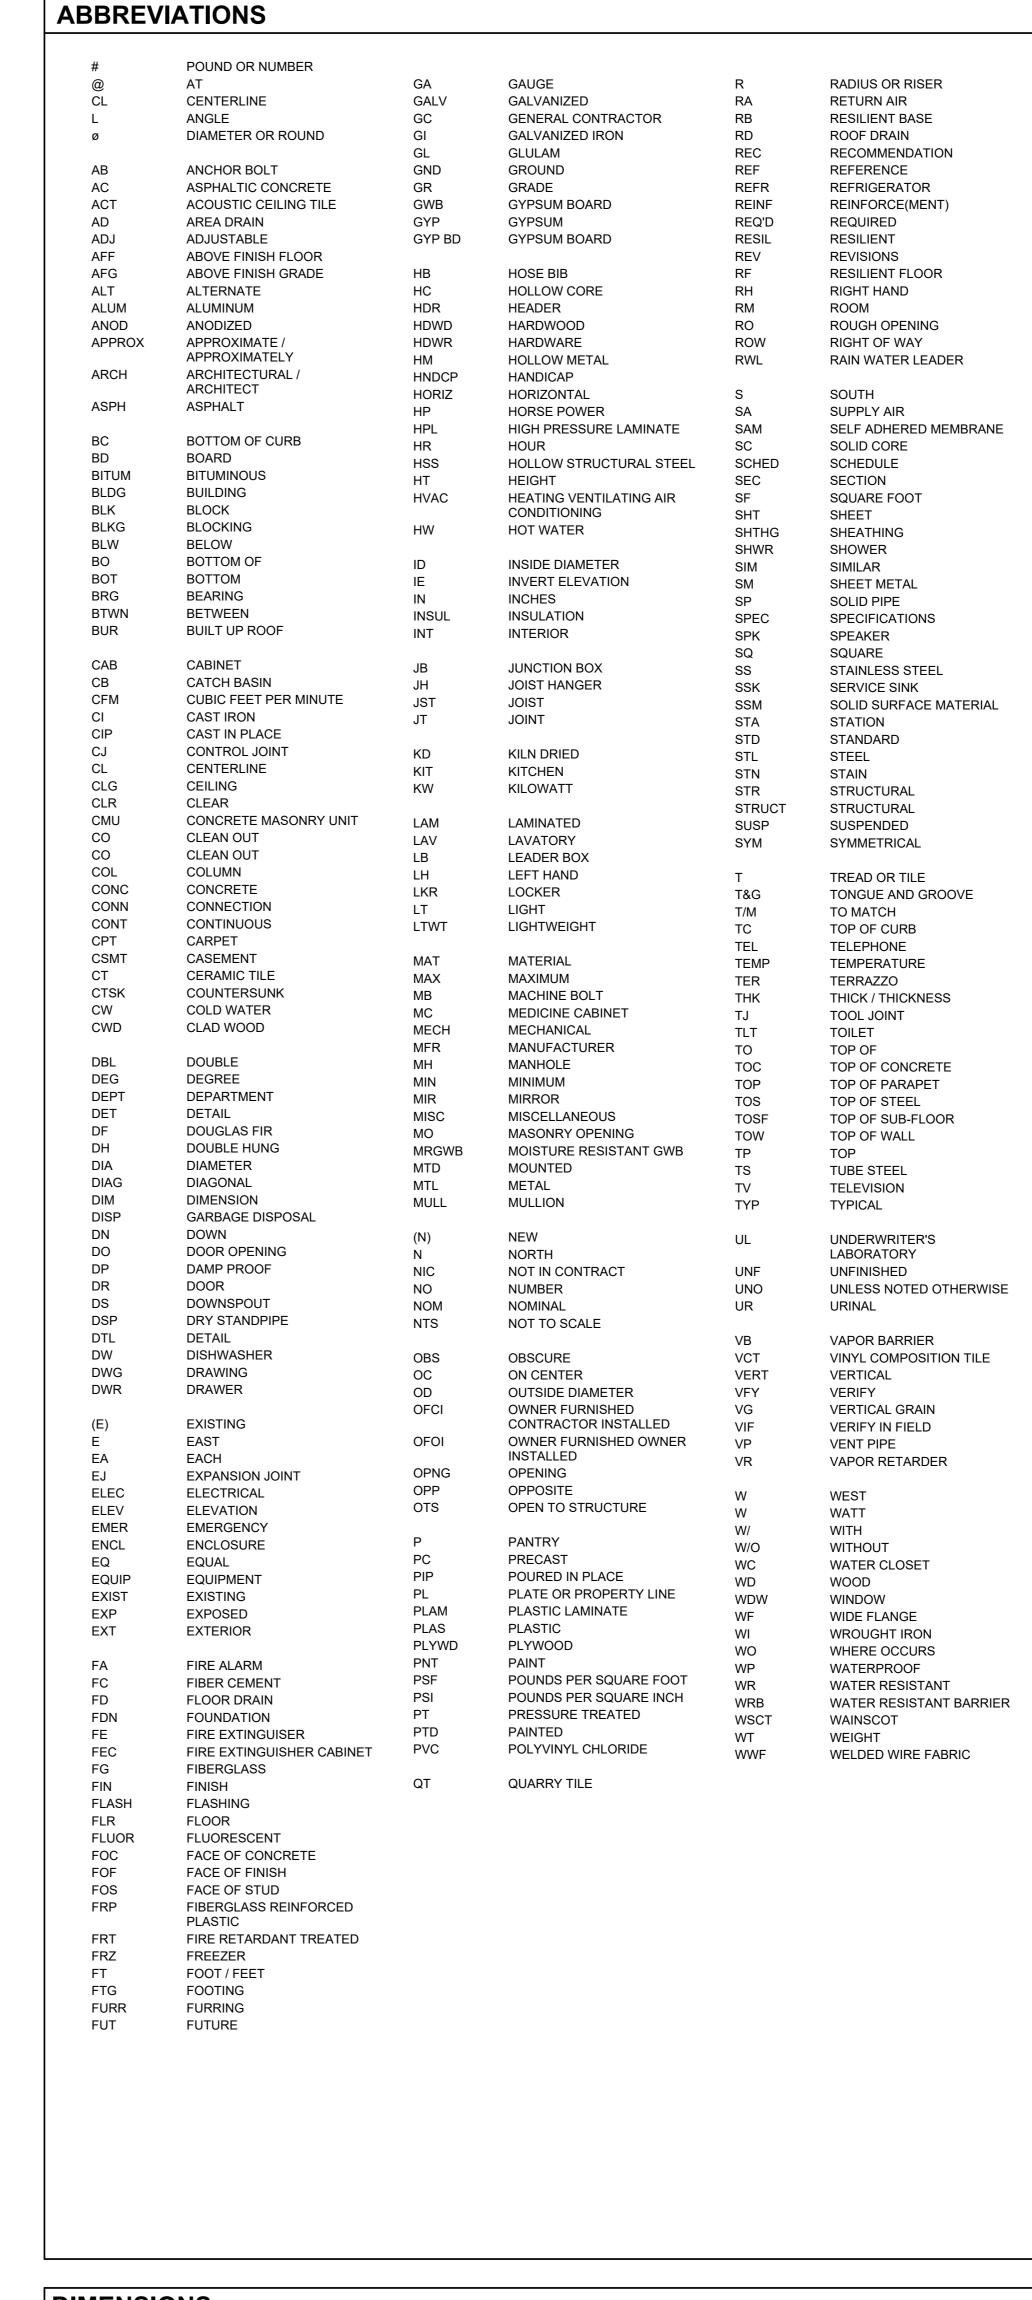

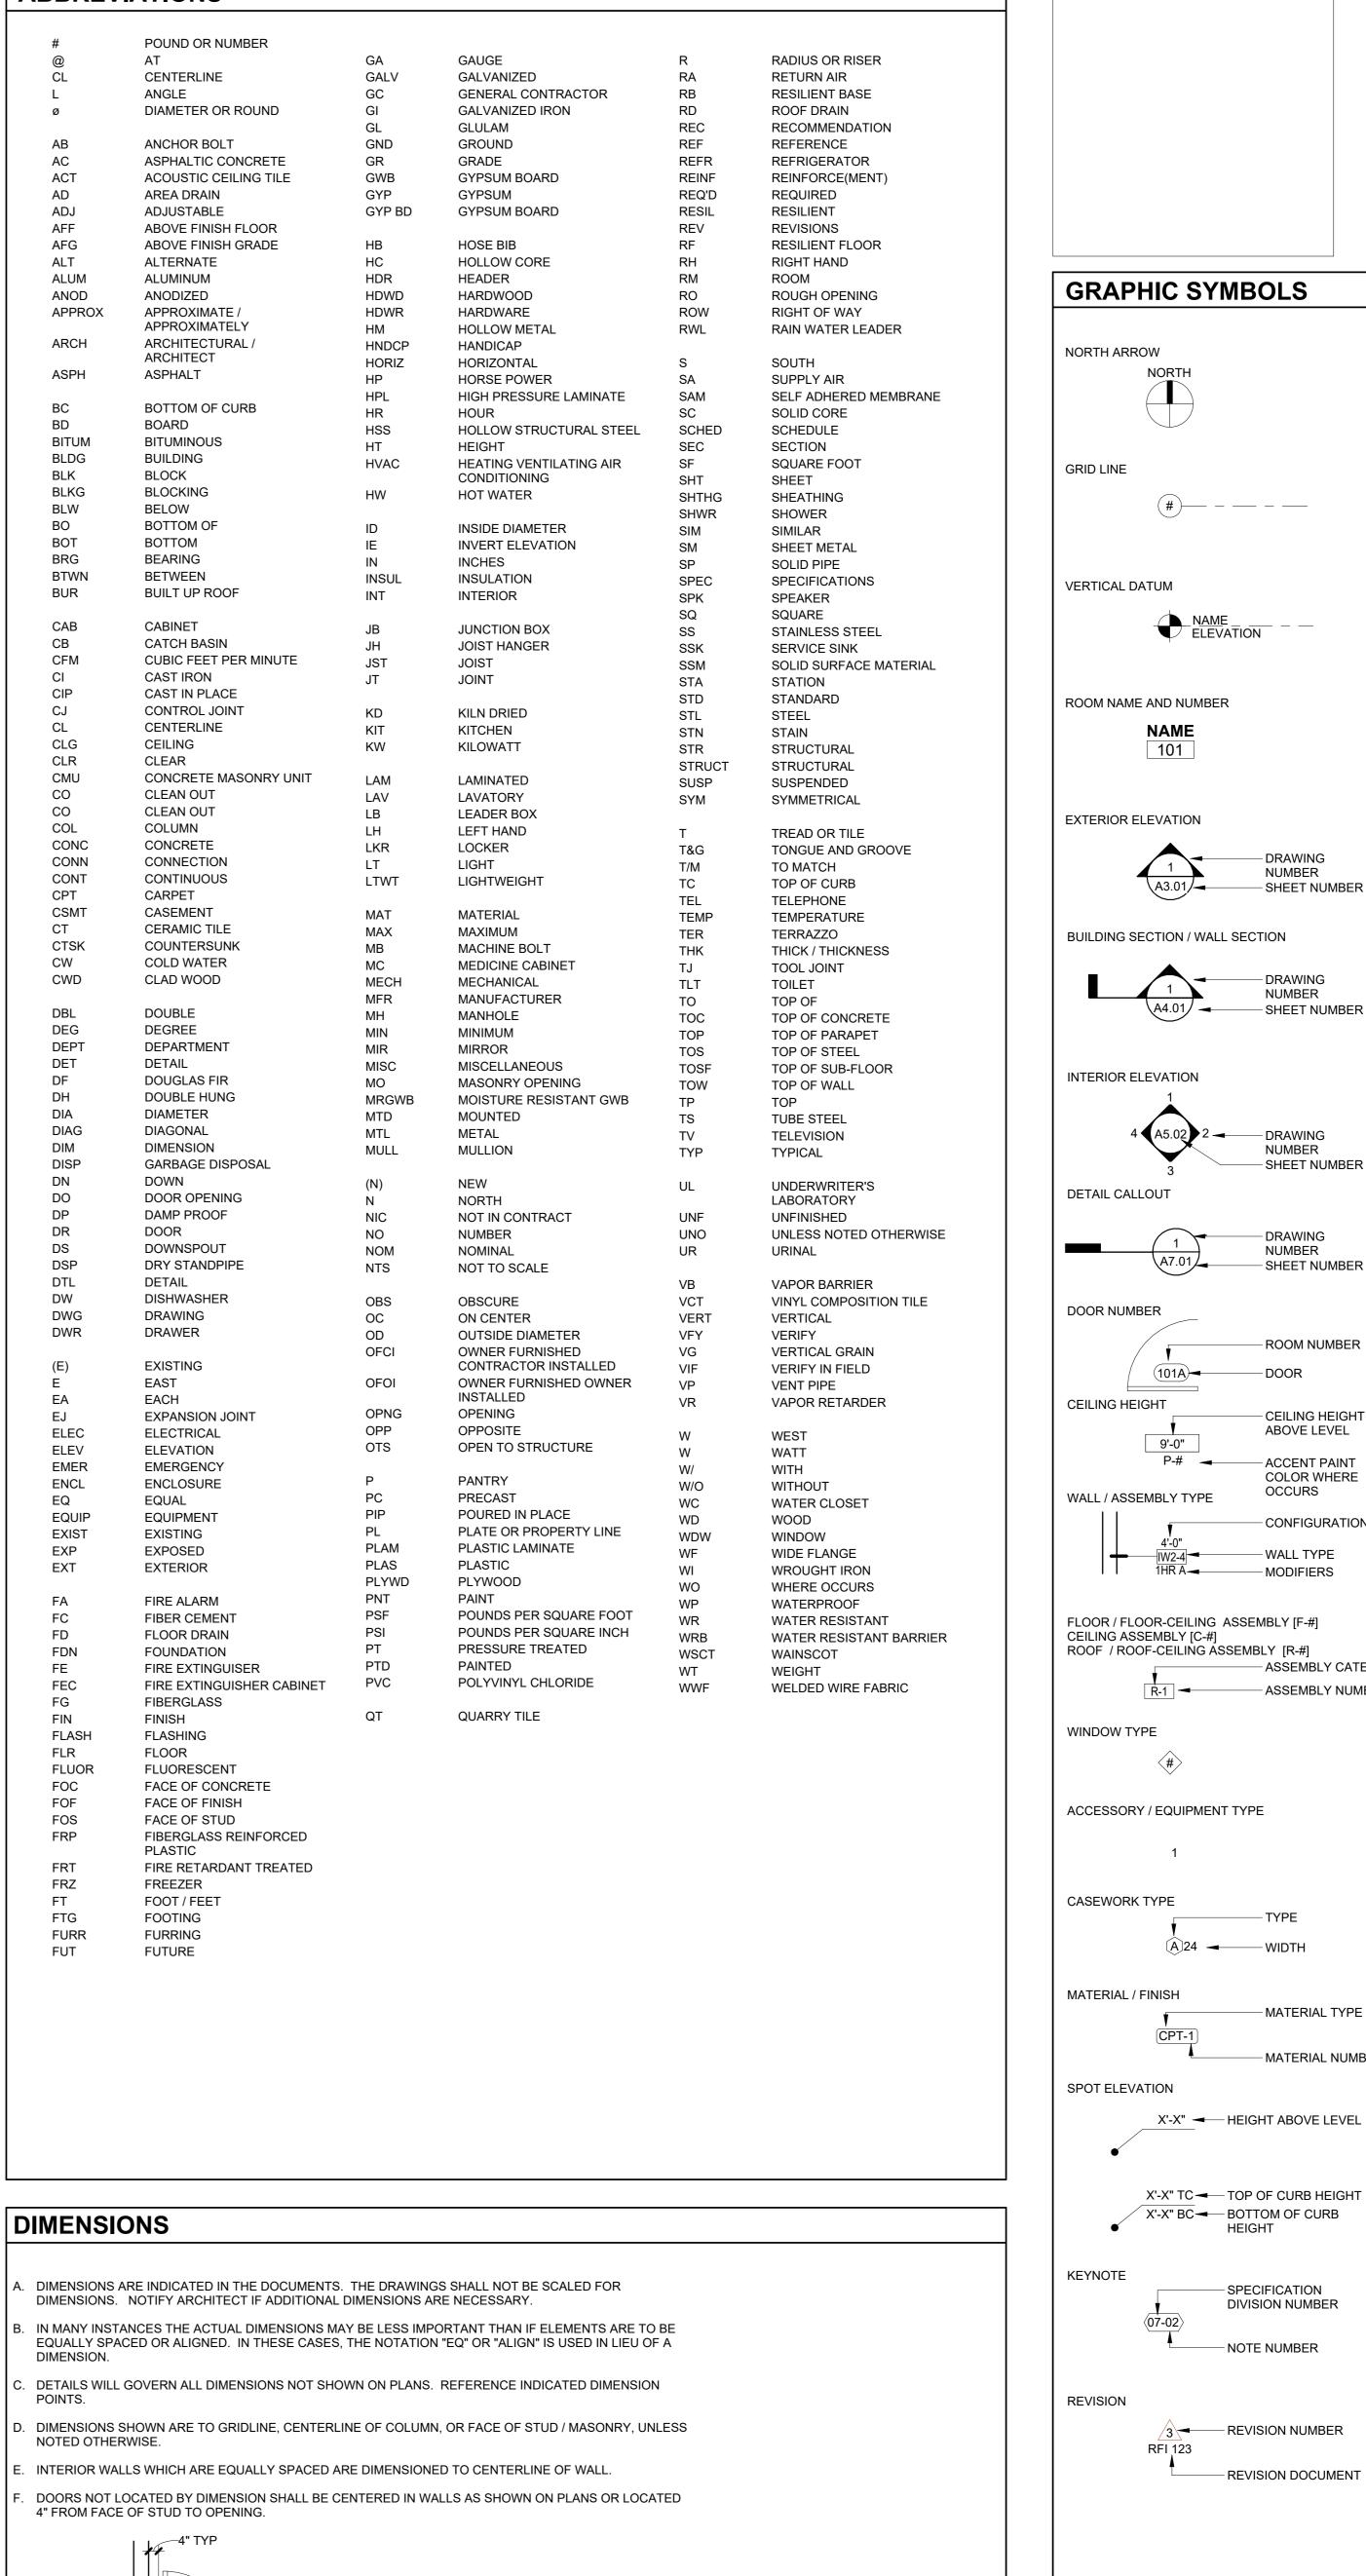



2525 E Burnside St. Portland, OR 97214

503.226.3617

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#24115

Digitally signed by Sid Scott Date: 2025.01.06 16:36:08-08'00' **Clackamas Fire District:** Station 12

Job Number:

18081 S Harding Rd

Oregon City, OR 97045

NAME ____ _ _ _ _

- DRAWING NUMBER - SHEET NUMBER

BUILDING SECTION / WALL SECTION

- DRAWING NUMBER A4.01/ ← SHEET NUMBER

4 **♦** A5.02 **≥** 2 **→** DRAWING NUMBER — SHEET NUMBER

- DRAWING

NUMBER - SHEET NUMBER

- ROOM NUMBER — DOOR - CEILING HEIGHT ABOVE LEVEL

- ACCENT PAINT COLOR WHERE OCCURS - CONFIGURATION WALL TYPE

1HR A MODIFIERS

FLOOR / FLOOR-CEILING ASSEMBLY [F-#] ROOF / ROOF-CEILING ASSEMBLY [R-#] - ASSEMBLY CATEGORY - ASSEMBLY NUMBER

- MATERIAL TYPE

- MATERIAL NUMBER

ACCESSORY / EQUIPMENT TYPE

(A)24 ── WIDTH

X'-X" ── HEIGHT ABOVE LEVEL

X'-X" TC ─ TOP OF CURB HEIGHT / X'-X" BC ── BOTTOM OF CURB

- SPECIFICATION DIVISION NUMBER NOTE NUMBER

REVISION NUMBER

GENERAL NOTES AND DIAGRAMS

ARCHITECTURAL

Sheet No:

BID SET

ISSUE


Drawing:

PERMIT SET


01.06.25

12.20.24


EXISTING EAST ELEVATION 1/8" = 1'-0"

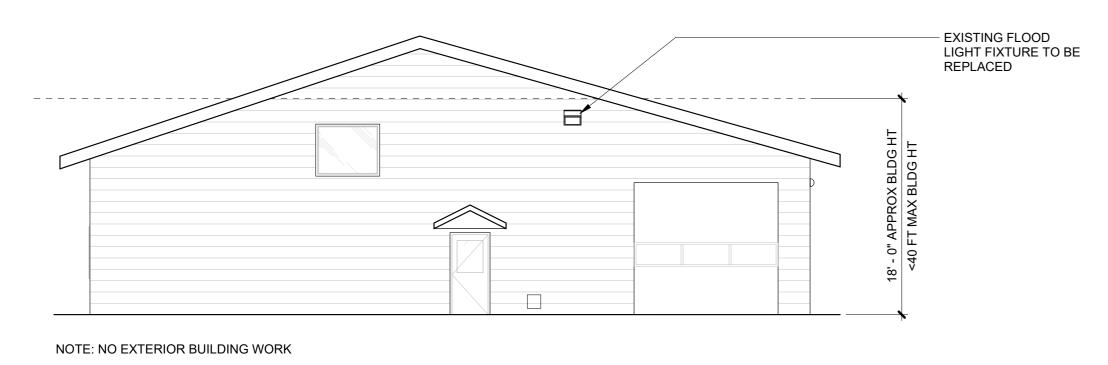


EXISTING WEST ELEVATION

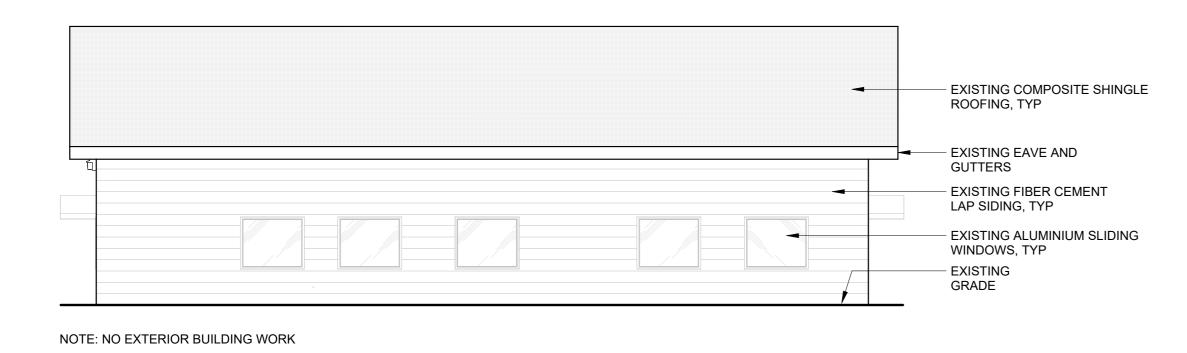


EXISTING NORTH ELEVATION1/8" = 1'-0"

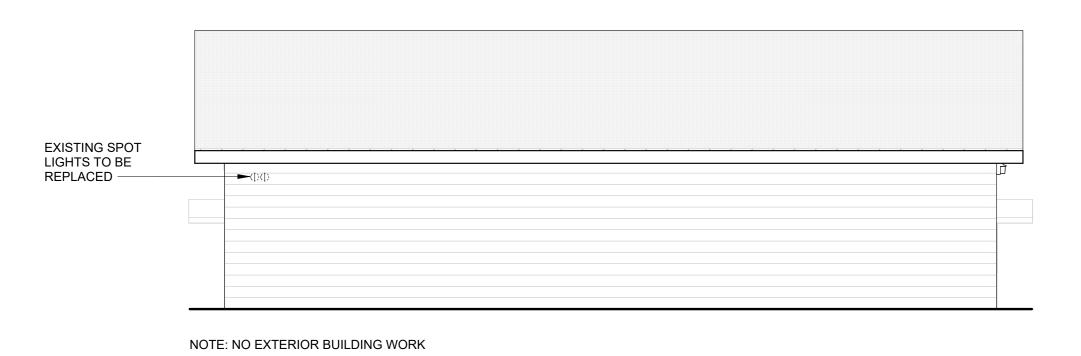

EXISTING SOUTH ELEVATION

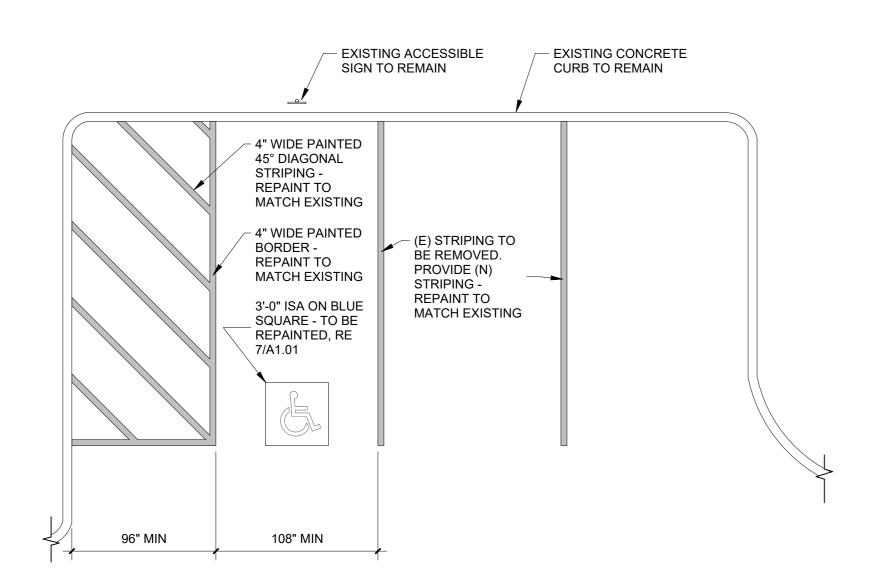


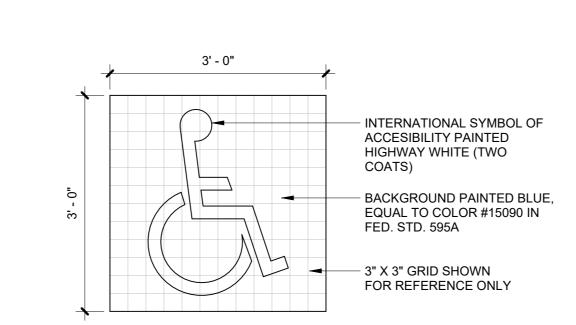


6 ACCESSIBLE PARKING
3/16" = 1'-0"

7 ACCESSIBLE PAVEMENT SIGN
3/4" = 1'-0"

1 SITE PLAN
1" = 20'-0"

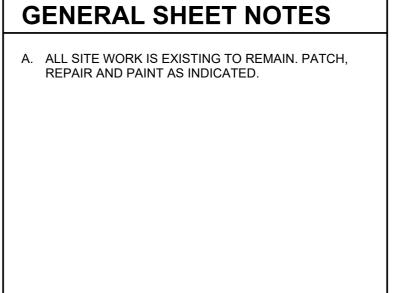

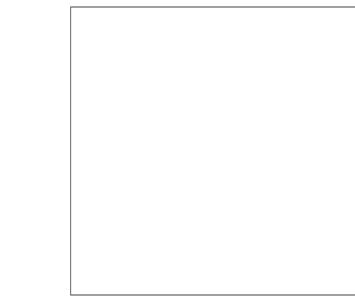



2525 E Burnside St.
Portland, OR 97214

SIDNE I SCOTT


PORTLAND, OREGON

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Date: 2025.01.06 16:36:41-08'00'

Clackamas Fire
District:
Station 12
Job Number: #24115

18081 S Harding Rd Oregon City, OR 97045



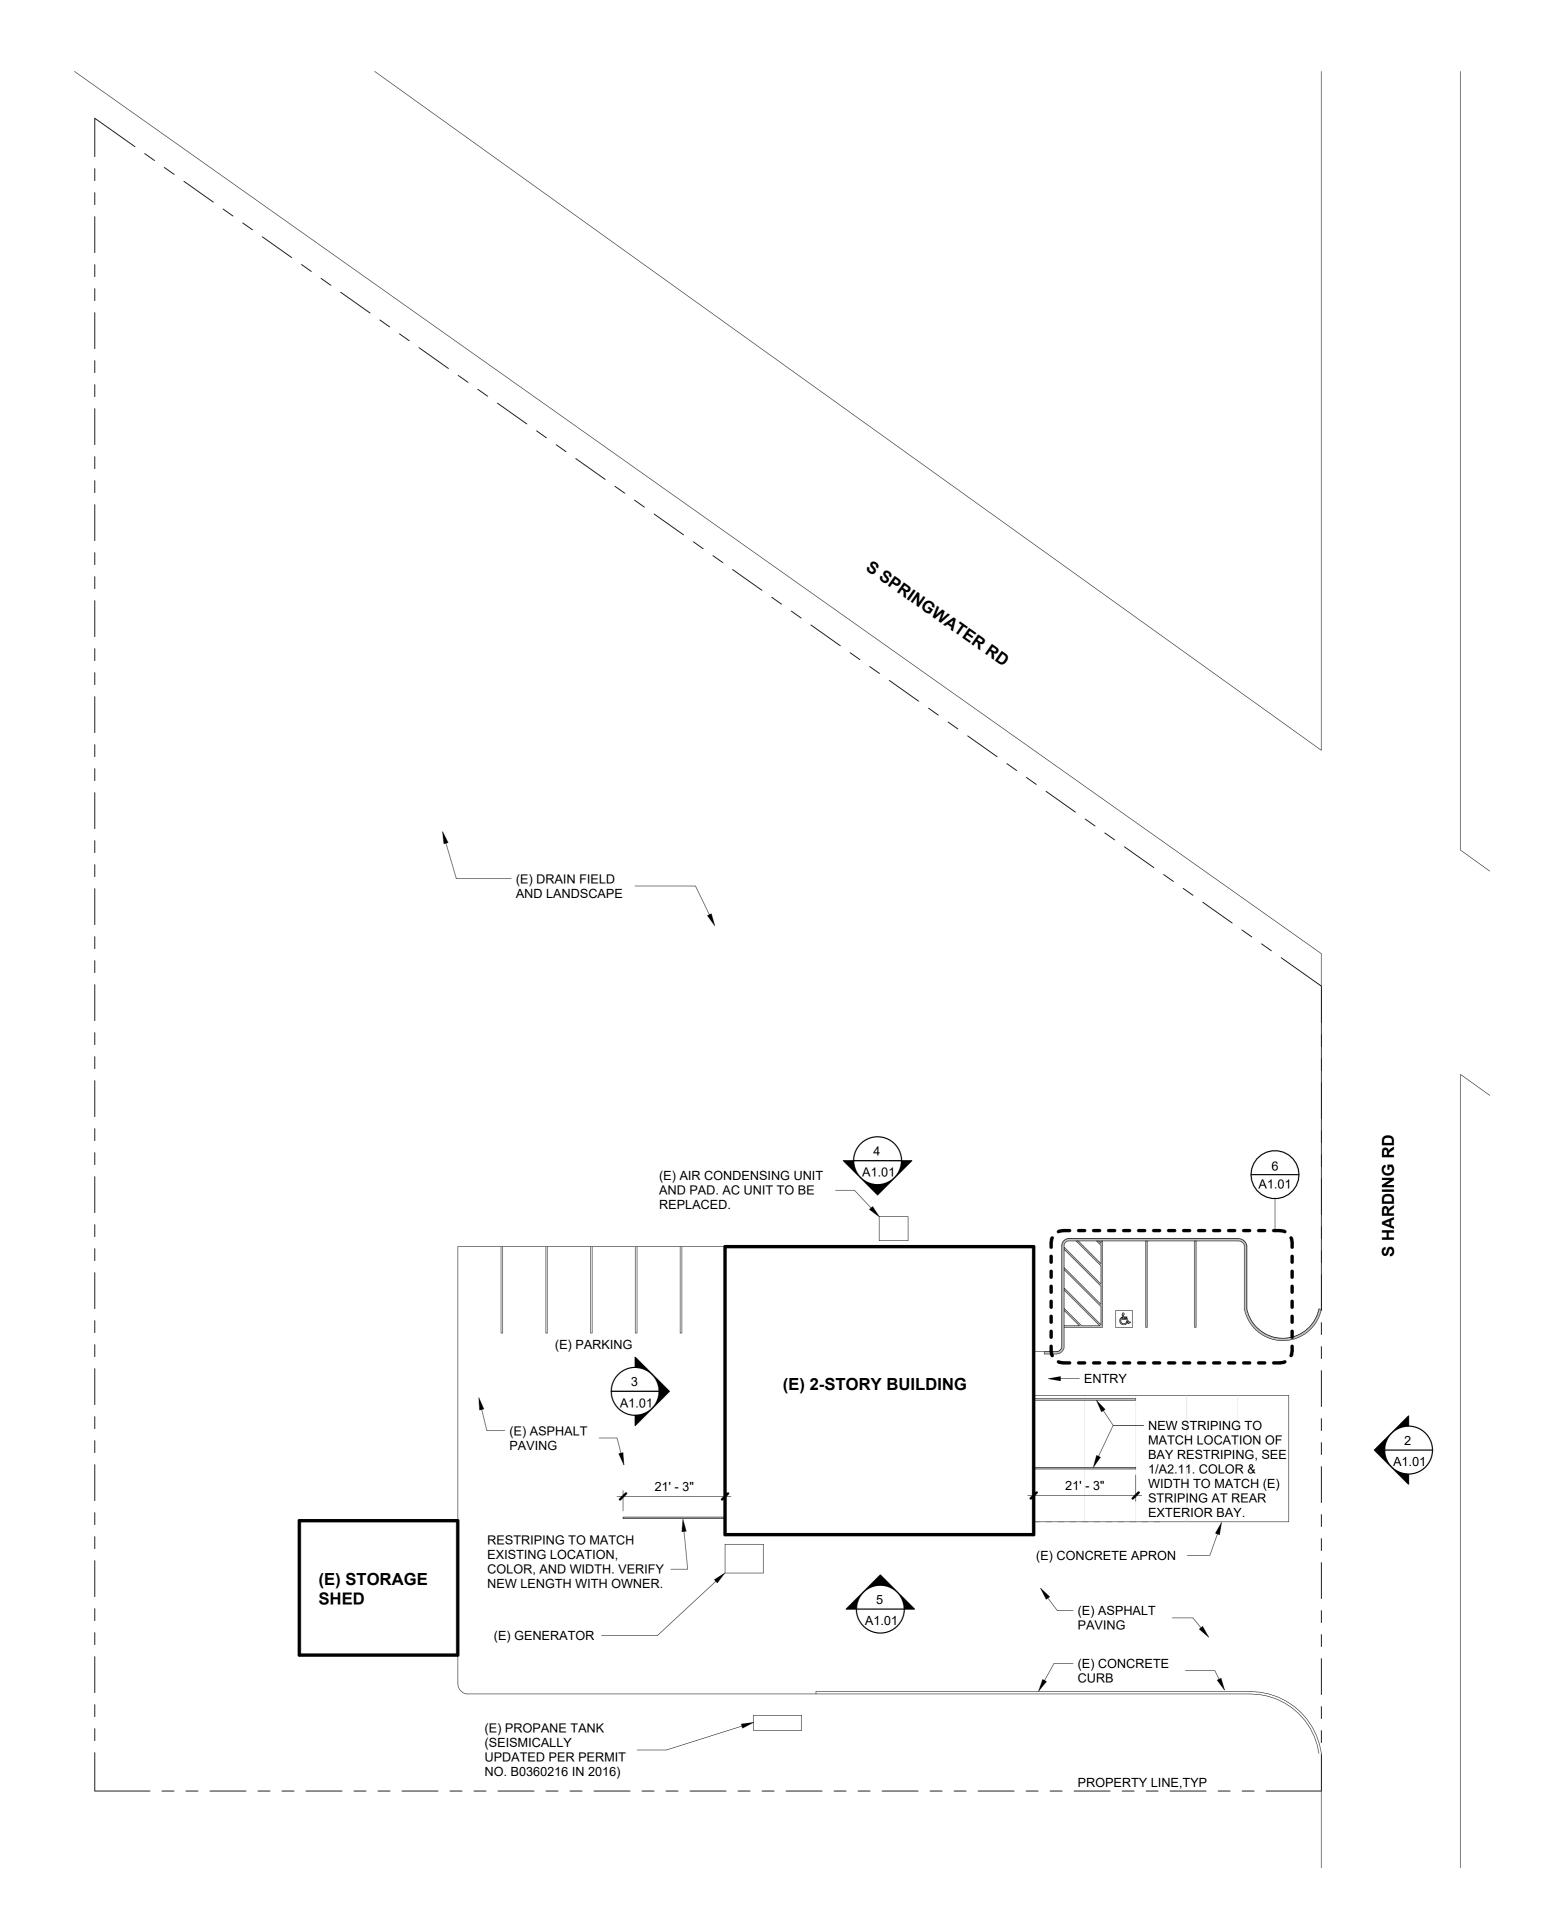

BID SET
PERMIT SET

ISSUE

Drawing:

SITE PLAN/ EXTERIOR ELEVATIONS


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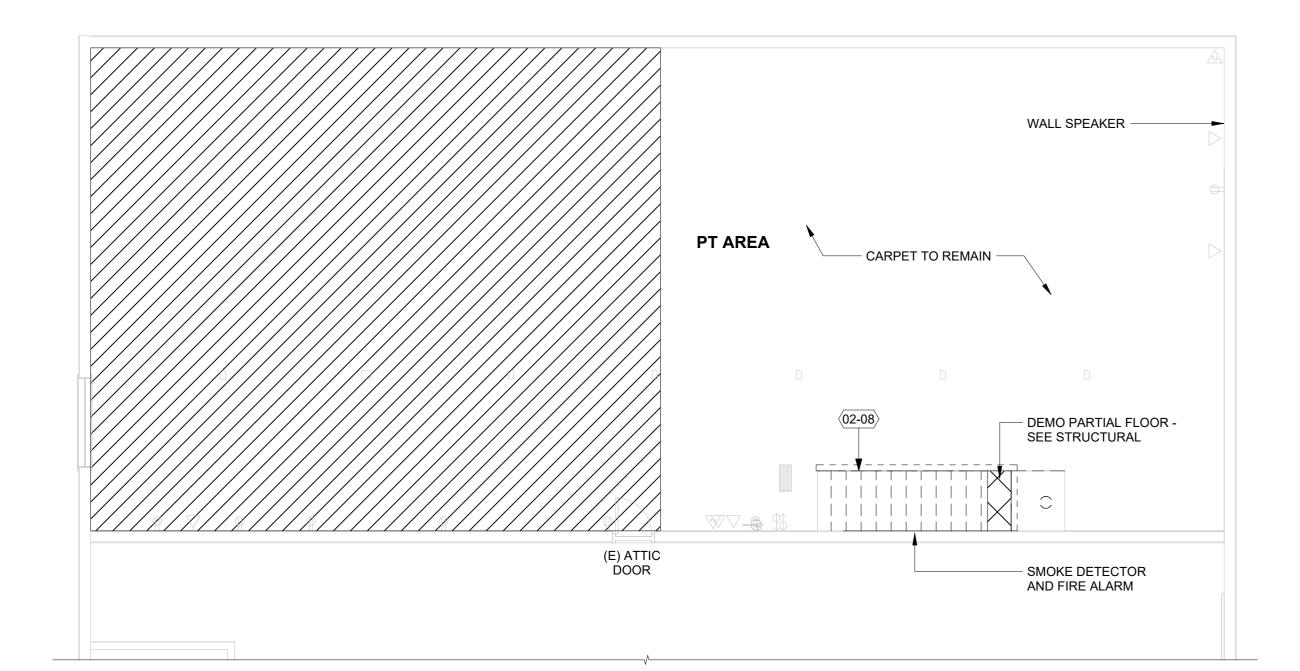
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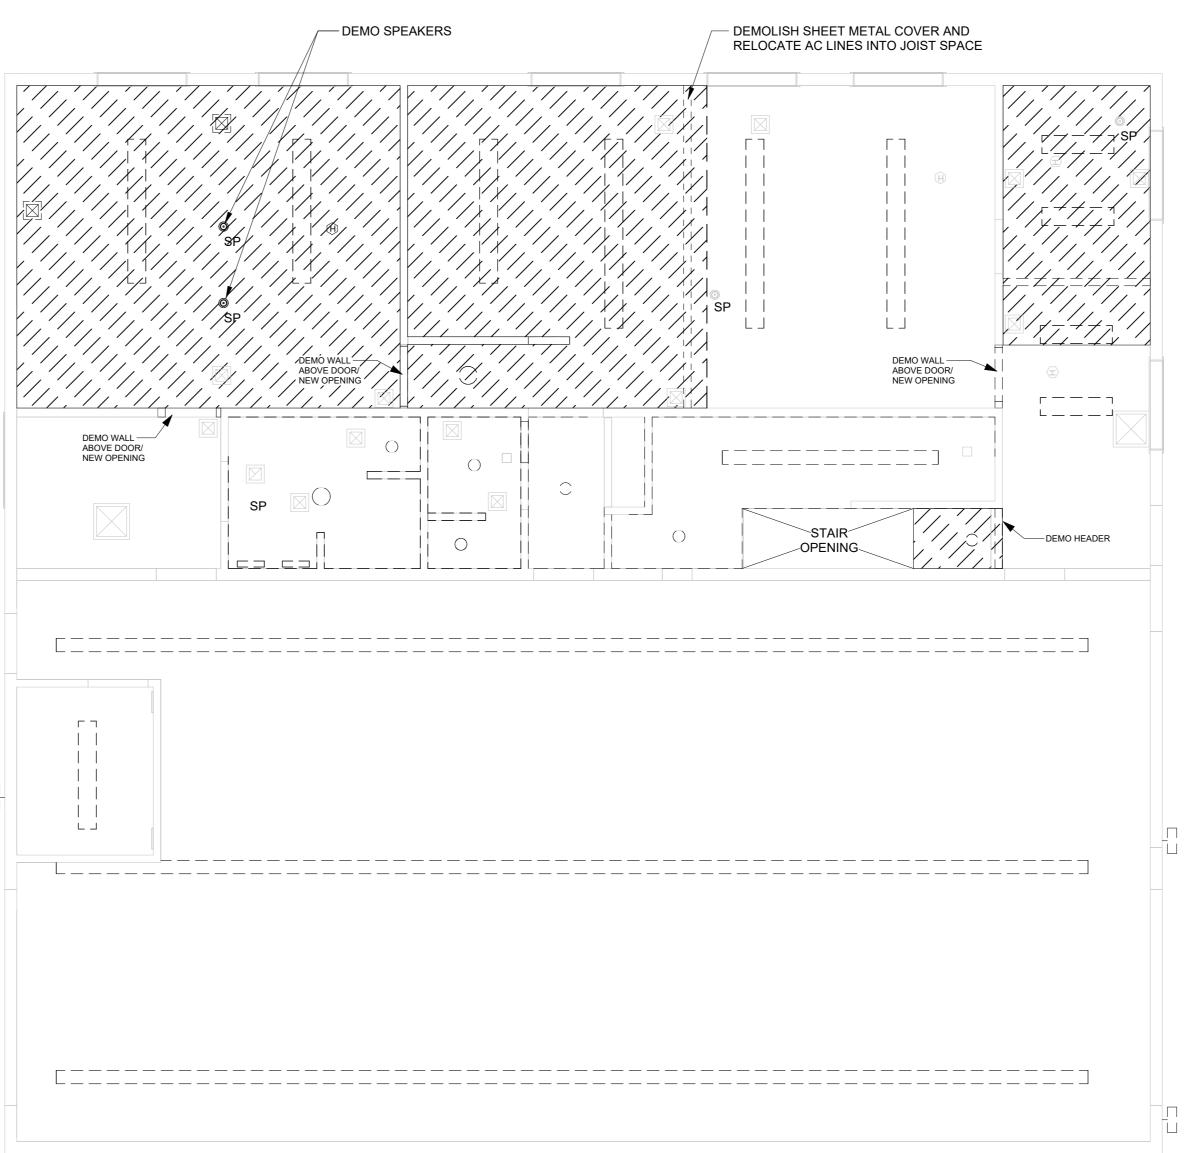
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DEMOLITION PLAN - FIRST FLOOR




DEMOLITION PLAN - SECOND FLOOR



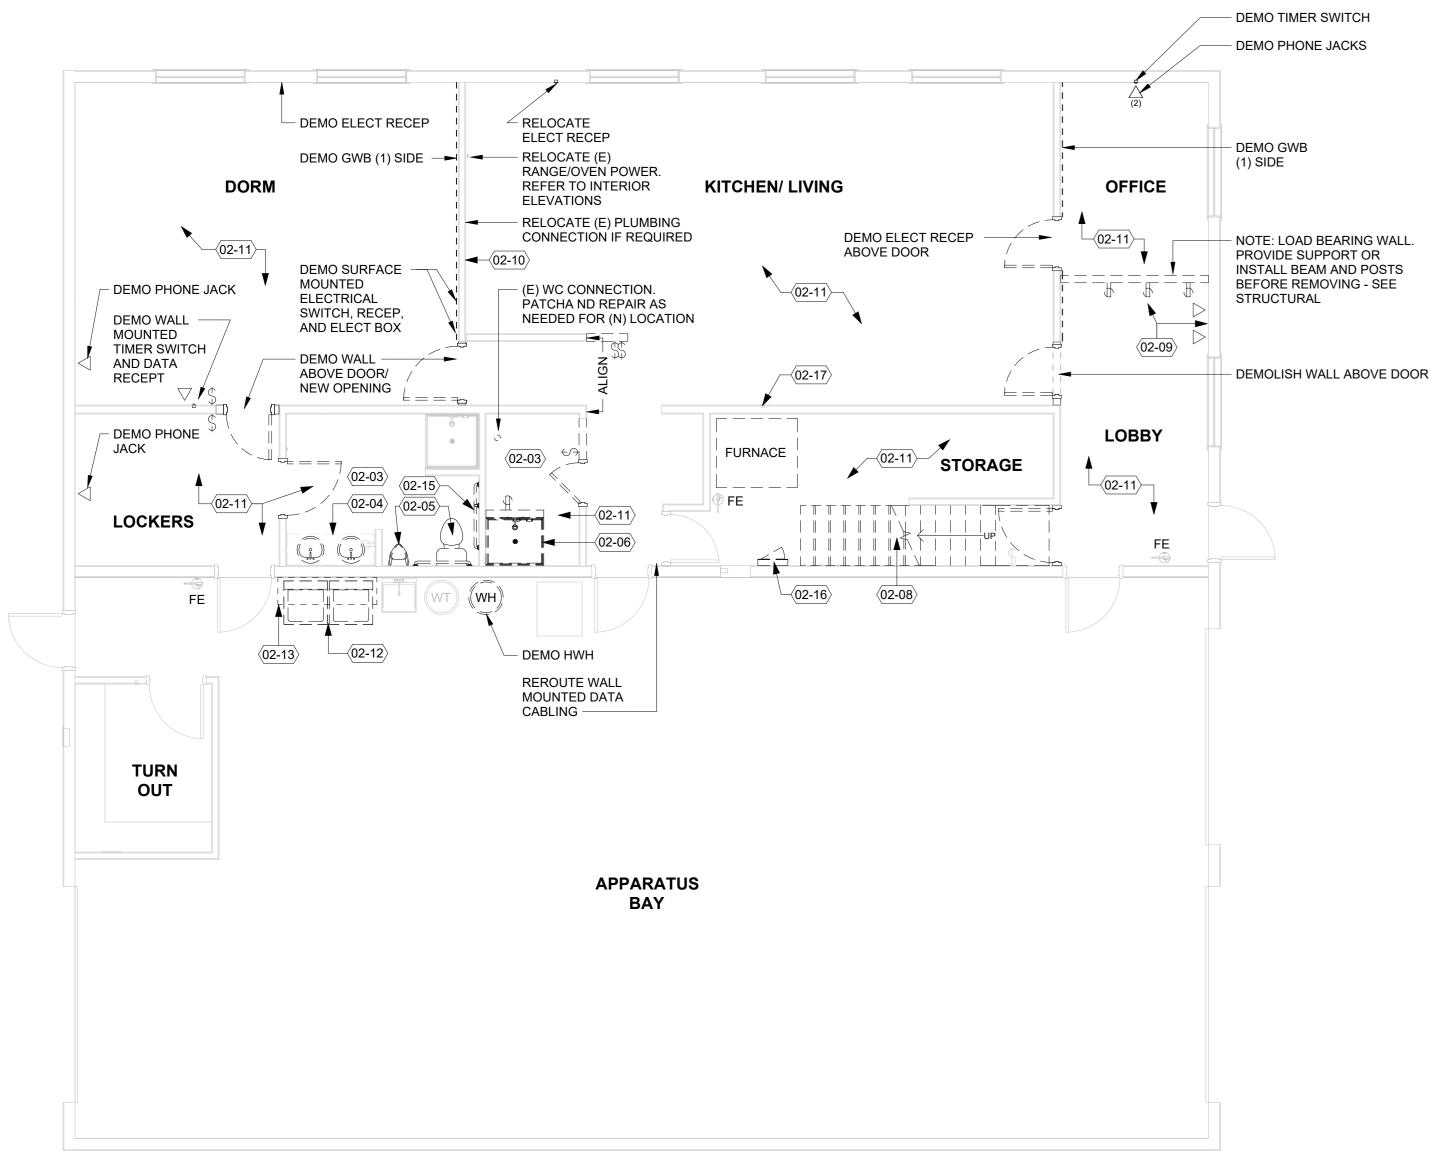

DEMOLITION REFLECTED CEILING PLAN - SECOND FLOOR3/16" = 1'-0"

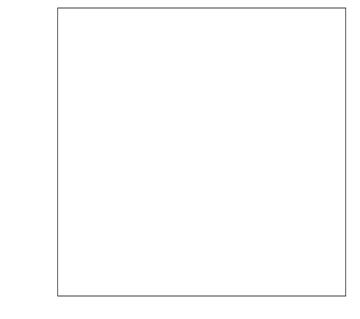

DEMOLITION PLAN SHEET

2525 E Burnside St. Portland, OR 97214

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Clackamas Fire

District:

Job Number:

Station 12

18081 S Harding Rd

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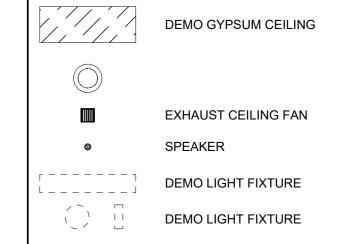
- A. COMPLY WITH ALL APPLICABLE LOCAL CODES AND ORDINANCES CONCERNING DEMOLITION OPERATIONS, RECYCLING, AND RESTRICTIVE REMOVAL.
- B. LIMITS OF DEMOLITION SHOWN IS FOR GENERAL GUIDANCE ONLY. CONTRACTOR SHALL ASCERTAIN THE FULL EXTENT OF DEMOLITION REQUIRED TO ACCOMMODATE THE NEW WORK AND PRODUCE A CONSISTENT APPEARANCE. PROVIDE TEMPORARY EXITING AS REQUIRED AND
- APPROVED BY LOCAL FIRE MARSHALL. D. COORDINATE ALL DEMOLITION AND SALVAGE WITH OWNER. OWNER TO COORDINATE REMOVAL OF EXISTING FURNISHINGS, FIXTURES AND **EQUIPMENT UNLESS NOTED OTHERWISE**
- . CONTRACTOR SHALL BE RESPONSIBLE FOR SHORING OF EXISTING STRUCTURE AS REQUIRED. CONTRACTOR SHALL VERIFY EXISTING CONDITIONS AND NOTIFY ARCHITECT
- IMMEDIATELY OF DISCREPANCIES. G. EXISTING SANITARY CONNECTION WILL NEED TO BE IN-FILLED AND SLAB CUT/CORED FOR NEW CONNECTION.
- H. REFER TO KEYNOTE 02-11; REMOVE FLOORING, BACKING, ADHESIVE, ETC DOWN TO CONCRETE AND/OR FLOOR SHEATHING IN PREPARATION FOR NEW FLOORING AND/OR CONCRETE SEALING.
- PREP FOR NEW WALL BASE DEMOLISH CEILING TEXTURE AT LOBBY, OFFICES DORM, KITCHEN/LIVING, STORAGE, LOCKERS, TOILET ROOMS, PT AREA, APPARATUS BAY

DEMO FLOOR PLAN LEGEND

DEMOLISH ALL WALL BASE THROUGHOUT AND

EXISTING TO REMAIN DEMOLISH ITEM DEMOLISH DOOR AND DEMOLISH CARPET FLOORING SWITCH SINGLE SWITCH DOUBLE SINGLE DATA OUTLET

DEMO RCP LEGEND




KEYNOTES

- 02-03 DEMOLISH TOILET ROOM ACCESSORIES AND WALL COVERING 02-04 DEMOLISH SINK AND COUNTER. COORDINATE EXTENTS OF PLUMBING PIPING DEMOLITION WITH NEW WORK. 02-05 DEMOLISH URINAL AND TOILET. COORDINATE EXTENTS OF PLUMBING PIPING DEMOLITION WITH NEW WORK.
- 02-06 DEMOLISH SHOWER AND GWB FOR NEW SHOWER AND PLUMBING. COORDINATE EXTENTS OF PLUMBING PIPING DEMOLITION WITH NEW WORK.
- 02-08 DEMOLISH STAIR, RAILINGS AND SUPPORTING STRUCTURE. 02-09 DEMOLISH ALL SHELVING, CASEWORK, CHAIR RAIL, CONDUIT AND WALL FINISHES.
- 02-11 DEMOLISH ALL EXISTING FLOORING AT CONCRETE SLAB AND PREPARE FOR 02-12 SALVAGE WASHER/DRYER AND ASSOCIATED PLUMBING, TO BE RELOCATED. RETURN
- WASHER/DRYER TO OWNER. 02-13 DEMOLISH CASEWORK.
- 02-15 SALVAGE GRAB BARS 02-16 SALVAGE TELECOM EQUIPMENT 02-17 SALVAGE AVIDS TV & WALL BRACKET

02-10 PREPARE FOR NEW FINISHES.


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DEMOLITION PLANS



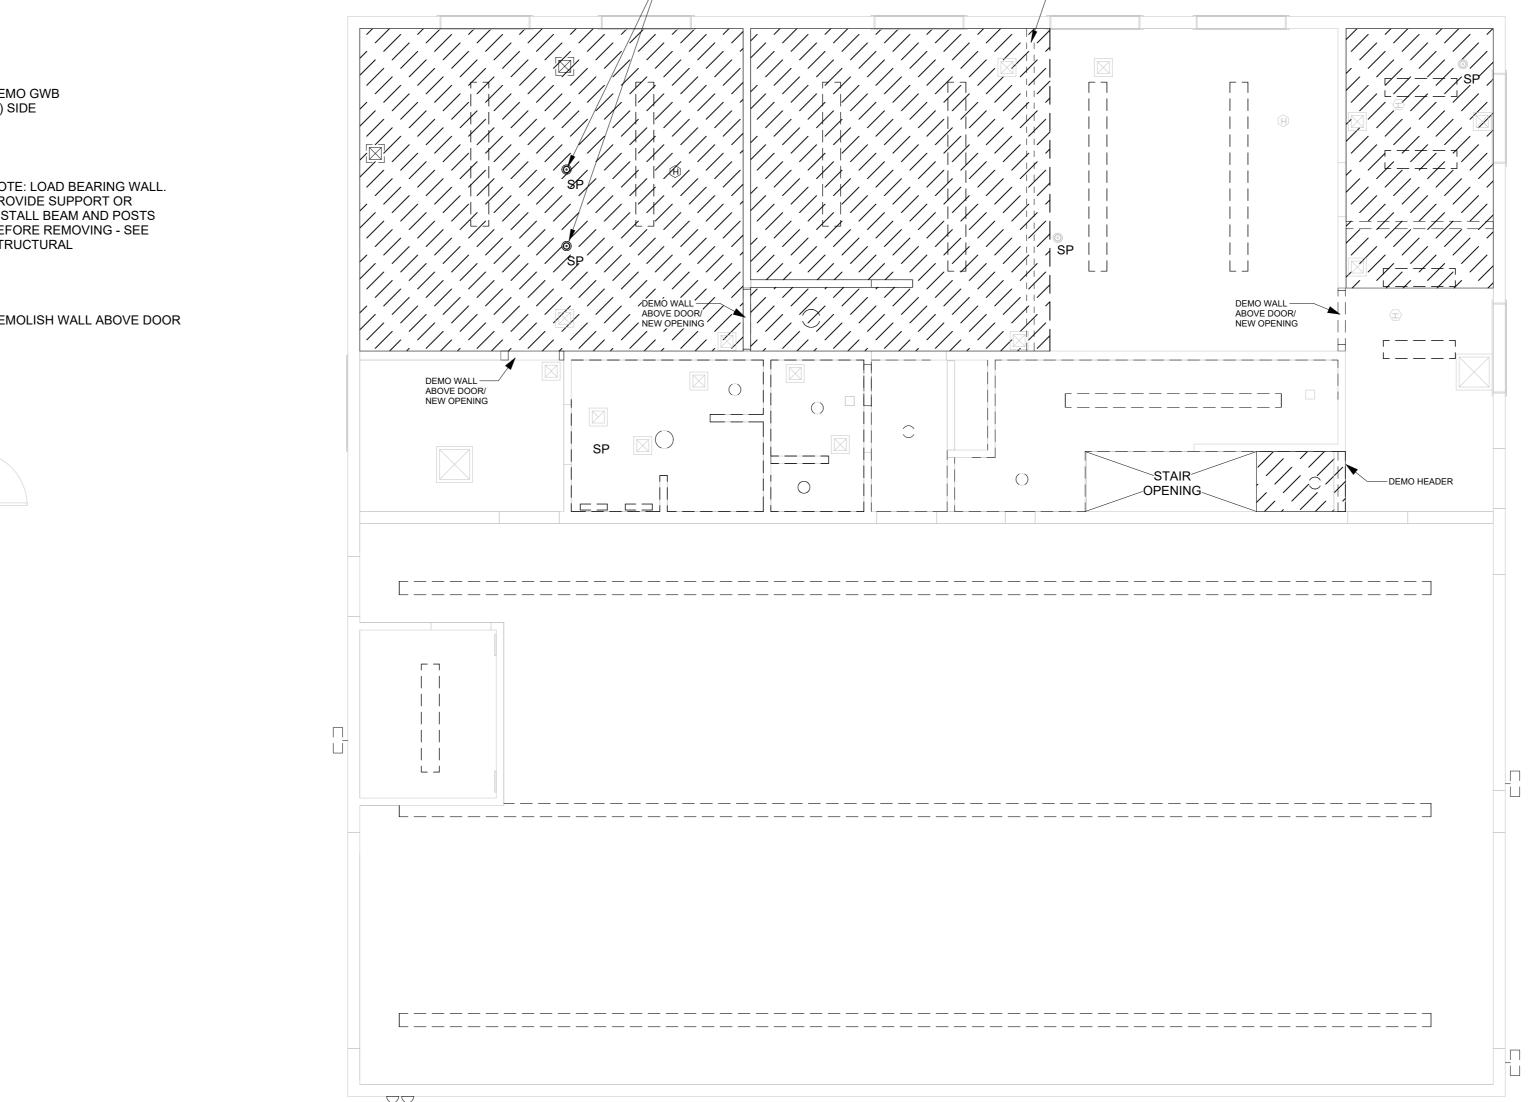



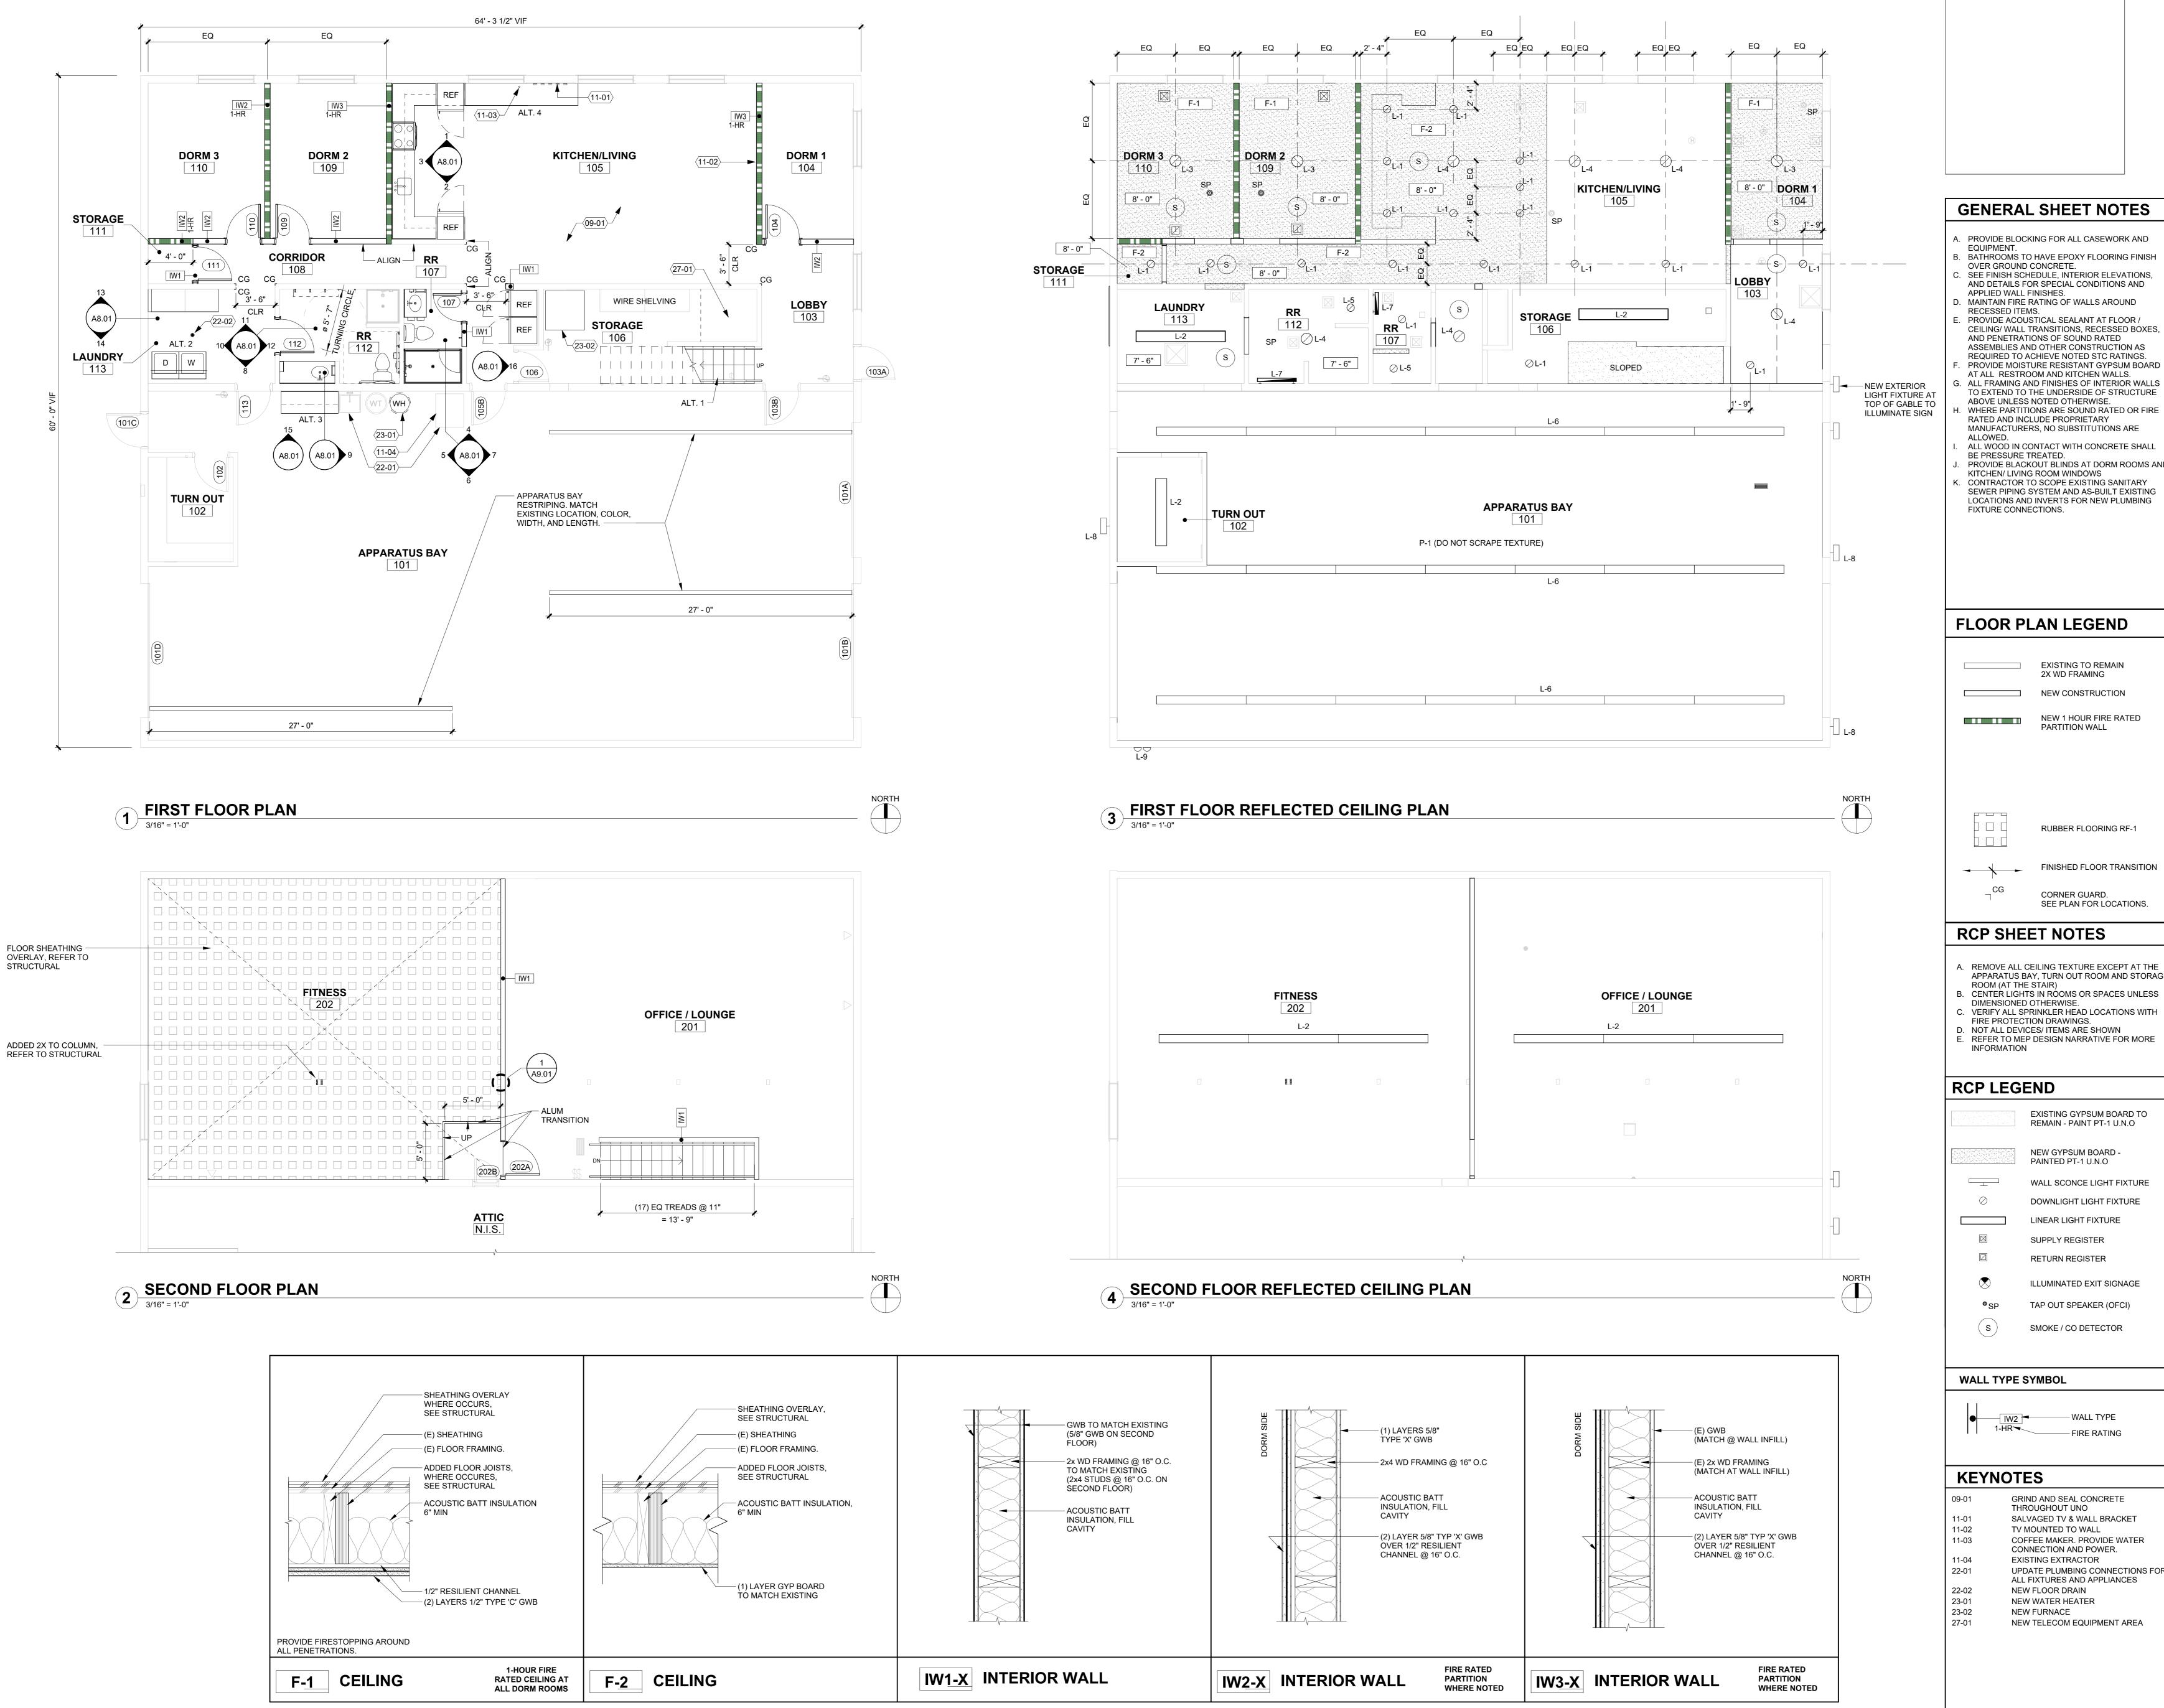

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Clackamas Fire BATHROOMS TO HAVE EPOXY FLOORING FINISH OVER GROUND CONCRETE. SEE FINISH SCHEDULE, INTERIOR ELEVATIONS, **District:** AND DETAILS FOR SPECIAL CONDITIONS AND

APPLIED WALL FINISHES. Station 12 MAINTAIN FIRE RATING OF WALLS AROUND

PROVIDE ACOUSTICAL SEALANT AT FLOOR / CEILING/ WALL TRANSITIONS, RECESSED BOXES, AND PENETRATIONS OF SOUND RATED ASSEMBLIES AND OTHER CONSTRUCTION AS REQUIRED TO ACHIEVE NOTED STC RATINGS.

AT ALL RESTROOM AND KITCHEN WALLS. ALL FRAMING AND FINISHES OF INTERIOR WALLS TO EXTEND TO THE UNDERSIDE OF STRUCTURE ABOVE UNLESS NOTED OTHERWISE. . WHERE PARTITIONS ARE SOUND RATED OR FIRE RATED AND INCLUDE PROPRIETARY
MANUFACTURERS, NO SUBSTITUTIONS ARE

ALL WOOD IN CONTACT WITH CONCRETE SHALL BE PRESSURE TREATED. PROVIDE BLACKOUT BLINDS AT DORM ROOMS AND KITCHEN/ LIVING ROOM WINDOWS . CONTRACTOR TO SCOPE EXISTING SANITARY

SEWER PIPING SYSTEM AND AS-BUILT EXISTING LOCATIONS AND INVERTS FOR NEW PLUMBING

FLOOR PLAN LEGEND

EXISTING TO REMAIN 2X WD FRAMING NEW CONSTRUCTION NEW 1 HOUR FIRE RATED

PARTITION WALL

RUBBER FLOORING RF-1 FINISHED FLOOR TRANSITION

RCP SHEET NOTES

A. REMOVE ALL CEILING TEXTURE EXCEPT AT THE APPARATUS BAY, TURN OUT ROOM AND STORAGE

ROOM (AT THE STAIR) B. CENTER LIGHTS IN ROOMS OR SPACES UNLESS DIMENSIONED OTHERWISE.

CORNER GUARD.

SEE PLAN FOR LOCATIONS.

C. VERIFY ALL SPRINKLER HEAD LOCATIONS WITH FIRE PROTECTION DRAWINGS. D. NOT ALL DEVICES/ ITEMS ARE SHOWN

E. REFER TO MEP DESIGN NARRATIVE FOR MORE INFORMATION

RCP LEGEND

EXISTING GYPSUM BOARD TO REMAIN - PAINT PT-1 U.N.O NEW GYPSUM BOARD -PAINTED PT-1 U.N.O WALL SCONCE LIGHT FIXTURE

DOWNLIGHT LIGHT FIXTURE LINEAR LIGHT FIXTURE SUPPLY REGISTER

RETURN REGISTER ILLUMINATED EXIT SIGNAGE TAP OUT SPEAKER (OFCI)

SMOKE / CO DETECTOR

— WALL TYPE 1-HR - FIRE RATING

KEYNOTES

GRIND AND SEAL CONCRETE THROUGHOUT UNO SALVAGED TV & WALL BRACKET TV MOUNTED TO WALL COFFEE MAKER. PROVIDE WATER CONNECTION AND POWER. EXISTING EXTRACTOR UPDATE PLUMBING CONNECTIONS FOR ALL FIXTURES AND APPLIANCES

NEW FLOOR DRAIN NEW WATER HEATER

NEW FURNACE NEW TELECOM EQUIPMENT AREA

Sheet No:

BID SET

ISSUE

Drawing:


PERMIT SET

FLOOR PLANS

01.06.25

12.20.24



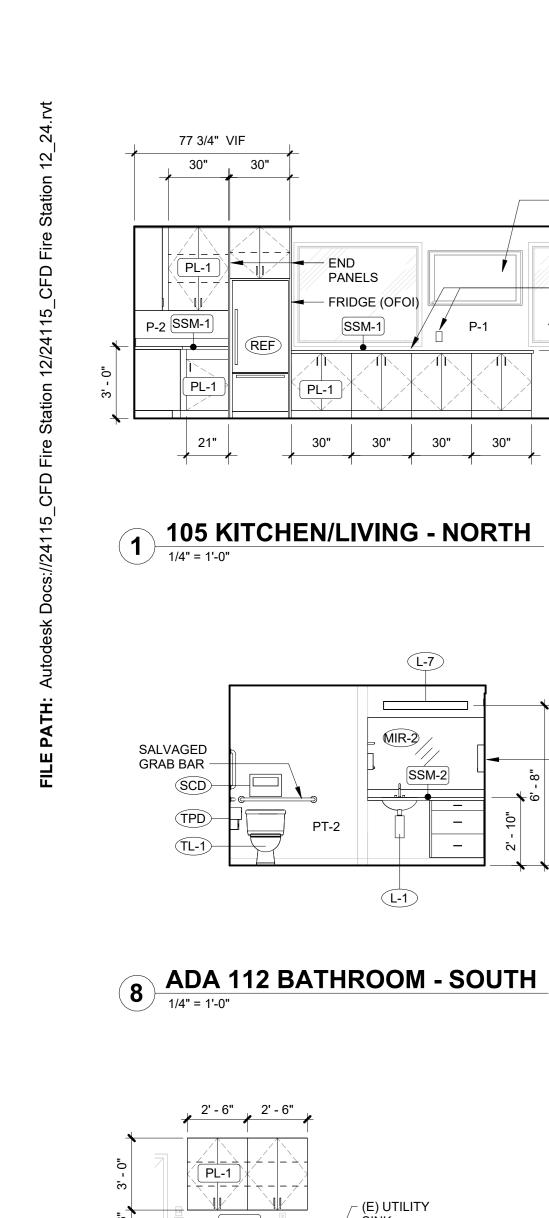

/ (E) UTILITY

SSM-1

15 EMS STORAGE

1/4" = 1'-0"


OWNER

- ENMOTION PT

REF REF

16 KITCHEN NOOK

FRIDGE (OFOI).
PROVIDE POWER

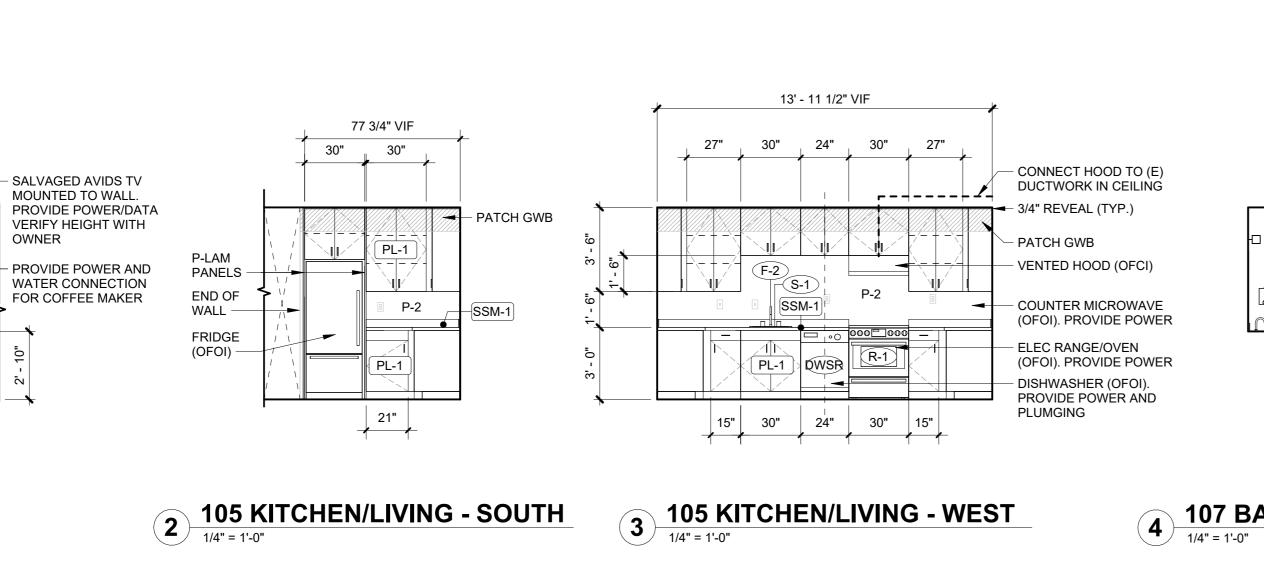


10 ADA 112 BATHROOM - WEST

48 X 8 P-LAM SHELF


WITH METAL BRACKETS

ADA 112 BATHROOM - NORTH

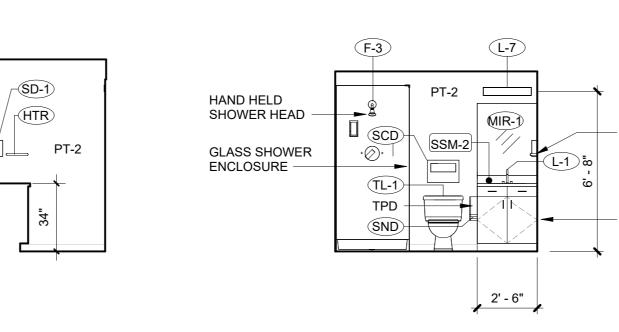

12 ADA 112 BATHROOM - EAST

- (E) SHOWER (E) SHOWER -

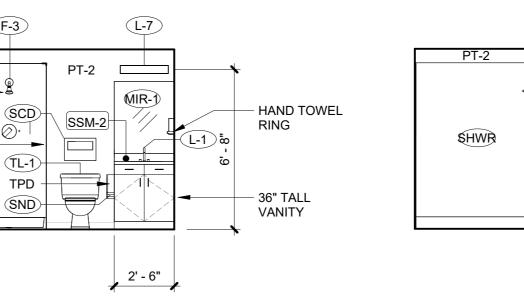

P-LAM FILLER

PL-1


3 1/2" 3' - 0" 3' - 0"


BEYOND

PANEL —

SALVAGED

GRAB BAR

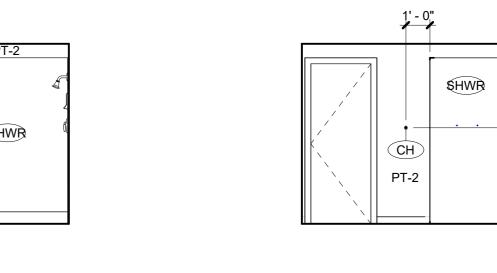

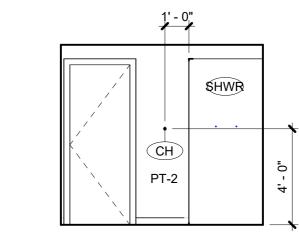

COORDINATE CABINET HEIGHT FOR TOP OR FRONT LOADING W/D.

14 113 LAUNDRY - SOUTH
1/4" = 1'-0"

UNLESS NOTED OTHERWISE. B. VERIFY ALL EQUIPMENT AND FURNISHINGS DIMENSIONS AND MOUNTING / BACKING REQUIREMENTS PER MANUFACTURER'S PROPER AND ADEQUATE PROVISIONS OF ALL REQUIRED UTILITY SIZING AND LOCATION, AND FOR INSTALLATION AND ANCHORAGE OF EQUIPMENT.

HEIGHT CABINETS, ACCESSORIES, VISUAL DISPLAY BOARDS, WALL MOUNTED SHELVING AND ANY WALL-MOUNTED EQUIPMENT INCLUDING THOSE PROVIDED BY OWNER. D. FIELD VERIFY ALL DIMENSIONS AND REQUIRED EQUIPMENT CLEARANCES PRIOR TO FABRICATION

INSTALL GROMMET HOLES IN COUNTERTOP ABOVE ALL ELECTRICAL AND DATA DEVICES. COORDINATE LOCATIONS W/ OWNER IN FIELD. WOOD-LOOK AND PLASTIC LAMINATE WITH PATTERN OR GRAIN DIRECTION TO RUN VERTICALLY ON VERTICAL SURFACES UNLESS NOTED OTHERWISE.

A. ALL GYPSUM BOARD WALLS TO BE PAINTED P-1,

District: Station 12 Job Number:

18081 S Harding Rd Oregon City, OR 97045

Digitally signed by Sid Scott Date: 2025.01.06 16:36:33-08'00'

Clackamas Fire

503.226.3617

seallp.com

#24115

2525 E Burnside St. Portland, OR 97214

GENERAL SHEET NOTES

SPECIFICATIONS. COORDINATE WORK TO ENSURE PROVIDE BACKING AT UPPER CABINETS, FULL

OF CABINETRY.

KEYNOTES

BID SET PERMIT SET

> ISSUE Drawing:

INTERIOR ELEVATIONS

01.06.25

12.20.24

3/4" PLYWOOD SUB TOP

2' - 0"

TYPE F (ACCESSIBLE RR)

1" = 1'-0"


/

TOP OF PARTIAL HT WALL
1 1/2" = 1'-0"

SOLID SURFACE COUNTER

AND BACKSPLASH

3/4" PLYWD SUB TOP

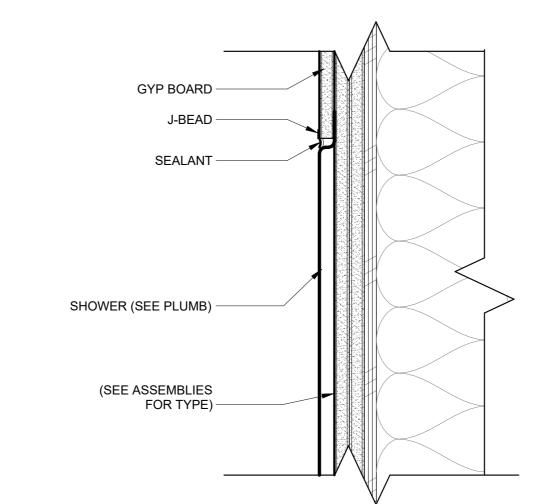

2 SHOWER DETAIL
3" = 1'-0"

- ACOUSTIC PUTTY PAD AROUND JUNCTION BOX (SEE ELECTRICAL)

ACOUSTIC INSULATION

ISOLATION STRIP BENEATH

ACOUSTIC SEALANT UNDER

SOLID SURFACE COUNTER AND BACKSPLASH

ELEVATION

- 3/4" PLYWD SUB TOP

GYPSUM BOARD

TRACK.

<u>TYPICAL</u> HORIZONTAL <u>PLAN</u>

TYPICAL SECTION AT FLOOR


SECTION


HANDRAIL DETAIL


1 1/2" = 1'-0"

SEAL ALL AROUND PENETRATIONS
W/ BACKER ROD & SEALANT PER
MANF. INSTRUCTIONS


3 ACOUSTIC WALL DETAIL
3" = 1'-0"

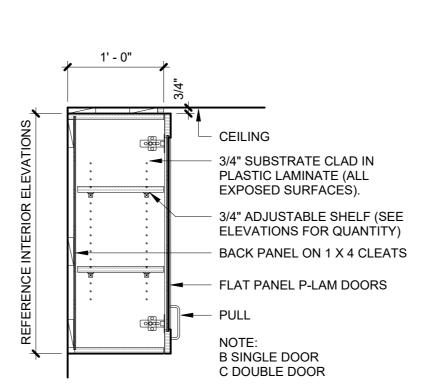

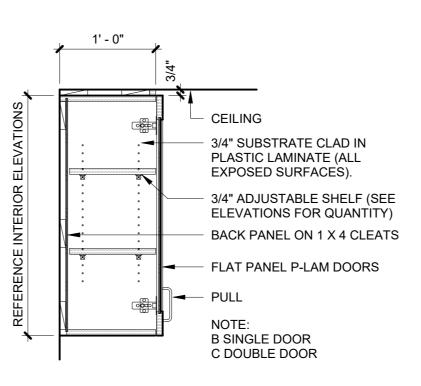

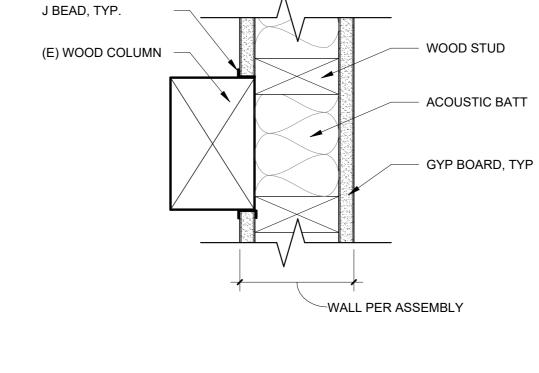

1 COLUMN @ WALL
3" = 1'-0"

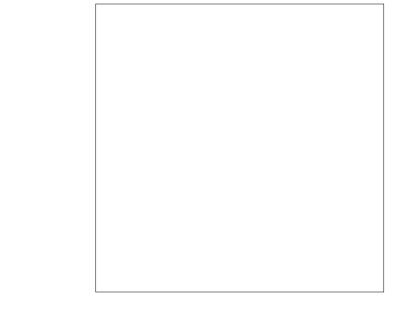





Digitally signed by Sid Scott Date: 2025.01.06 16:36:29-08'00' **Clackamas Fire District:** Station 12 #24115 Job Number:

18081 S Harding Rd Oregon City, OR 97045



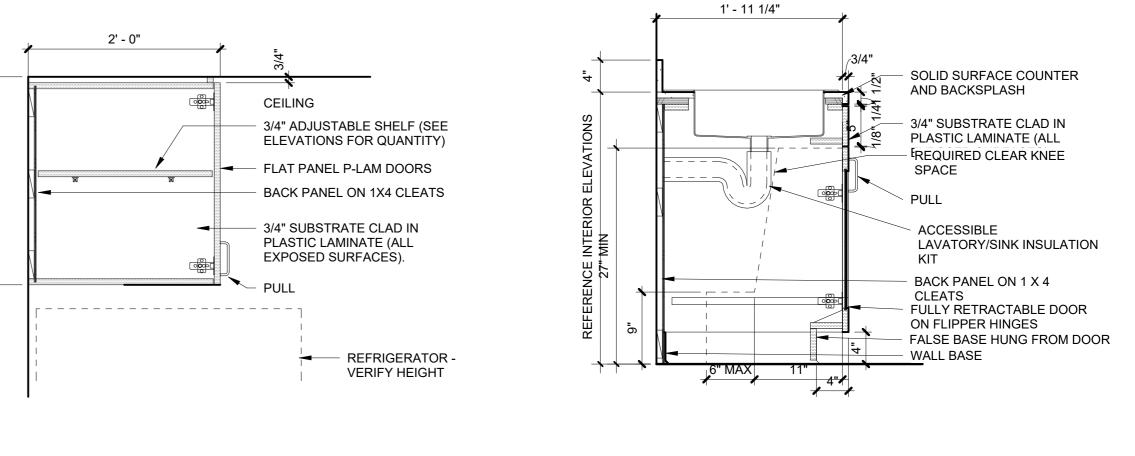

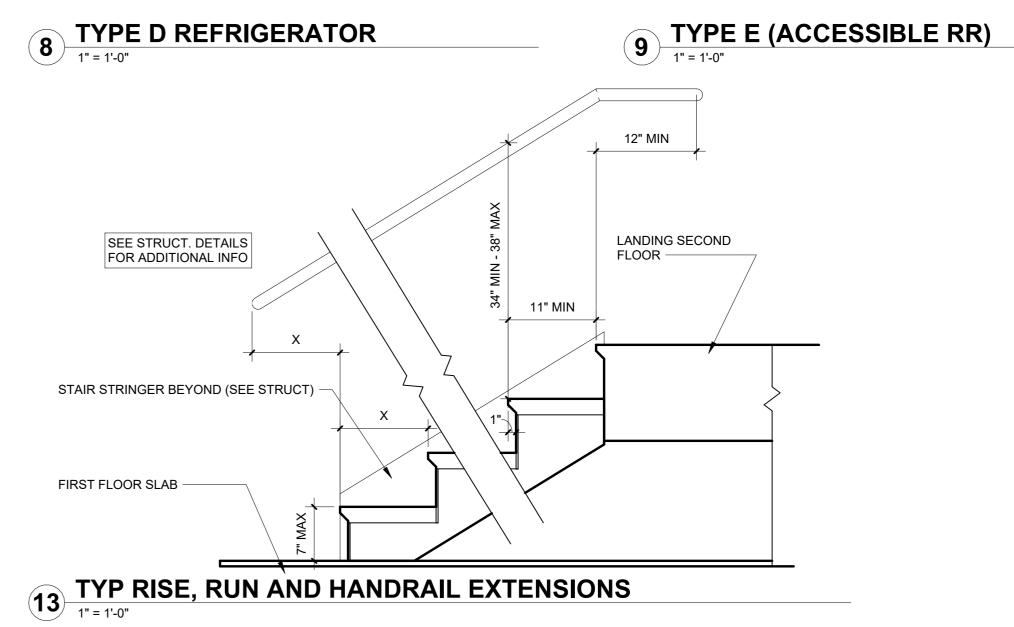

BID SET 01.06.25 PERMIT SET 12.20.24 DATE ISSUE Drawing:

INTERIOR DETAILS

THESE DRAWINGS ARE THE ORIGINAL UNPUBLISHED WORK OF THE ARCHITECT AND MAY NOT BE DUPLICATED OR USED

I LEGEND				
	PLASTIC	LAMINATE	WALL PR	OTECTION
RUBBER WALL BASE TARKETT VINYL BASE W/TOE TBD 4"	PL-1 MFR PATTERN COLOR DIRECTION	PLASTIC LAMINATE WILSONART BEIGEWOOD 7850 - GRAIN DIRECTION TO RUN VERTICALLY	MFR PRODUCT SIZE MATERIAL TEXTURE MOUNTING	CORNER GUARDS CONSTRUCTION SPECIALTIES ACROVYN CO SERIES 2" X FULL HEIGHT STAINLESS STEEL - ADHERED
	RUBBER	FLOORING	FRP-1	FIBERGLASS REINFORCED PLASTIC
	RF-1 MFR PRODUCT COLOR SIZE	RUBBER FLOORING ZANDUR TECHNE RUBBER TN3902 MALLET INTERLOCK 24"x24"	MFR PRODUCT COLOR TRIM	MARLITE SMOOTH 100G WHITE ALUM CAP AND BASE TRIM, PVC TRIM ALL OTHERS
EXISTING BROADLOOM CARPET	THICKNESS	9 MM		
- - -			WINDOW	TOTATHENE
- -	SOLID SU	RFACE	WINDOW	IREAIMENI
-	MFR PRODUCT	COUNTER/ BACKSPLASH CORIAN SOLID SURFACE	WT-1 MFR	BLACKOUT BLINDS
TE	FINISH THICKNESS	.5"	STYLE COLOR NOTES	- - A
GRIND AND SEALED (E) CONCRETE C GRIND AND EPOXY (E) CONCRETE	SSM-2 MFR PRODUCT COLOR FINISH THICKNESS	SOLID SURFACE (LAVS) CORIAN SOLID SURFACE WHITE 5"	A. BLACKO B. ALL INT C. GRIND A EXCEPT	EGEND NOTES OUT BLINDS ON FIRST FLOOR WINDOWS ERIOR WINDOW TRIM TO BE PAINTED PT-1 AND SEAL (E) CONCRETE THROUGHOUT IN ROOMS #101 APPARATUS BAY AND #102 TURN OUT
	FLOORIN	G TRANSITIONS	ROOM FII	NISH SCHEDULE NOTES
ENS: GSHELL, UNLESS NOTED OTHERWISE FLAT TYPICAL PAINT SHERWIN WILLIAMS LINEN WHITE B EPOXY PAINT (RESTROOMS) SHERWIN WILLIAMS LINEN WHITE	FLOORING TY	PE AND APPLICATION. SITIONS TO BE LOCATED AT CENTERLINE	A	
	RUBBER WALL BASE TARKETT VINYL BASE W/TOE TBD 4" EXISTING BROADLOOM CARPET	RUBBER WALL BASE TARKETT VINYL BASE WITOE TBD 4* RUBBER RF-1 MFR PATTERN COLOR DIRECTION RUBBER RF-1 MFR PRODUCT COLOR SIZE THICKNESS SOLID SU SSM-1 MFR PRODUCT COLOR FINISH THICKNESS FLOOR IN NS: 3SHELL, UNLESS NOTED OTHERWISE FLAT TYPICAL PAINT SHERWIN WILLIAMS LINEN WHITE B EPOXY PAINT (RESTROOMS) SHERWIN WILLIAMS	RUBBER WALL BASE TARKETT VINYL BASE WYTOE TID 4" RUBBER FLOORING RF-I DIRECTION RUBBER FLOORING RF-I DIRECTION RUBBER FLOORING RF-I DIRECTION RUBBER FLOORING RF-I DIRECTION RF-I DIRECTION RUBBER FLOORING RF-I DIRECTION RF-I DIRECTION RUBBER FLOORING RF-I DIRECTION RF-I DIRECTION RF-I DIRECTION RF-I DIRECTION RUBBER FLOORING RF-I DIRECTION RF-I DIRECTION RUBBER FLOORING RF-I DIRECTION RESIDENT COLOR FRODUCT COLOR FINSH DIRECTION RESIDENT SOLID SURFACE SSM-I COUNTER/ BACKSPLASH MER CORIAN PRODUCT COLOR FINISH THICKNESS SOLID SURFACE WILLOW FINISH THICKNESS S' SOLID SURFACE SSM-I COUNTER/ BACKSPLASH WILLOW FRODUCT COLOR FINISH THICKNESS SOLID SURFACE WILLOW FINISH THICKNESS SOLID SURFACE WILLOW FINISH THICKNESS SOLID SURFACE ULLOW FINISH THICKNESS SOLID SURFACE ULLOW FINISH THICKNESS S' FLOORING TRANSITIONS NS: SSHEELL, UNLESS NOTED OTHERWISE LAT TYPICAL PAINT SHERWIN WILLIAMS LINEN WHITE B EPOXY PAINT (RESTROOMS) SHERWIN WILLIAMS LINEN WHITE B EPOXY PAINT (RESTROOMS) SHERWIN WILLIAMS SHERWIN WILLIAMS LINEN WHITE B EPOXY PAINT (RESTROOMS) SHERWIN WILLIAMS SHERWIN WILLIAMS SHERWIN WILLIAMS LINEN WHITE B EPOXY PAINT (RESTROOMS) SHERWIN WILLIAMS SHERWIN W	RUBBER WALL BASE TARKETT VINYL BASE WITOE TIPD 4* RUBBER FLOORING REPATIEN BEIGEWOOD 7850 COLOR DIRECTION GRAIN DIRECTION TO RUN VERTICALLY RUBBER FLOORING REPATION REPATIO

	DESCRIPTION	MANUFACTURER	MODEL	FINISH	COMMENTS
PTD-1	PAPER TOWEL DISPENSER	GEORGIA-PACIFIC	ENMOTION 59488A	BLACK	
HTR	HAND TOWEL RING	OFOI	-	-	
MIR-1	30"x36" MIRROR	BOBRICK	B-290	STAINLESS	
MIR-2	60"x36" MIRROR	BOBRICK	B-290	STAINLESS	VIF
TPD	TOILET PAPER DISPENSER	BOBRICK	B-540	STAINLESS	
SND	SANITARY NAPKIN DISPOSAL	BOBRICK	B-35139	STAINLESS	
SD-1	SOAP DISPENSER	GEORGIA-PACIFIC	ENMOTION 52057	BLACK	
SCD	SEAT COVER DISPENSER	BRADLEY	583	STAINLESS	
CH	COAT HOOK	BOBRICK	B-9541	STAINLESS	1
(L-1)	LAVATORY	SLOAN	DSWD-83000	SSM-2	SEE FINISH LEGEND
(L-2)	LAVATORY	AMERICAN STANDARD	9024.001EC	WHITE	
(F-1)	FAUCET	MOEN	9419	CHROME	
(F-2)	FAUCET	KOHLER	K-24982	POLISHED NICKEL	
(F-3)	FAUCET	MOEN	T8346EP15, 8371HD VALVE (VERIFY)	BRUSHED NICKEL	@ SHOWER
S-1	SINK	ELKAY	ECTRU21179TC	POLISHED SATIN	
TL-1	TOILET	KOHLER	K-31620-0	WHITE	SOFT CLOSE SEAT
GB	GRAB BARS	BROBRICK	B-5806	STAINLESS	1.25" dia; 18"
B. CO	ONTRACTOR TO PROVIDE BLOC ONTRACTOR TO ROUTE UTILITE	ES IN WALL TO AVOID ALL RE		N.	

	DESCRIPTION	MANUFACTURER	MODEL	FINISH	COMMENTS
ÓWSR	DISHWASHER	OFOI	-	-	1, 2
R-1	RANGE	OFOI	-	-	2
RH	RANGE HOOD	OFCI	-	-	2, 4
REF	REFRIGERATOR	OFOI	VERIFY REQ. WITH OWNER	-	2
MW	MICROWAVE	OFOI	-	-	2
TV1	TV	OFOI	-	-	2, 3
TV2	AVIDS TV	OFOI	-	-	2, 3
W/D	WASHER AND DRYER	OFOI	VERIFY REQ. WITH OWNER	-	1, 2, 4
B. CO	ONTRACTOR TO PROVIDE BONTRACTOR TO ROUTE UTIL	LOCKING AS REQUIRED FOR AL LITES IN WALL TO AVOID ALL RE GHT DIAGRAMS AND INTERIOR E		ATION.	
 PF PF PF 	IMENTS ROVIDE PLUMBING AS REQUENTED ROVIDE POWER AS REQUIRED ENT TO THE OUTSIDE	ED			

ABBREVITIONS


OFOI = OWNER FURNISHED, OWNER INSTALLED

OFCI = OWNER FURNISHED, CONTRACTOR INSTALLED

	ROOM FINISH SCHEDULE														
		WALLS CEILING						ING							
				NORTH	EAST	SOUTH	WEST								
No.	ROOM NAME	FLOOR	BASE	FINISH	FINISH	FINISH	FINISH	MATERIAL	FINISH	COMMENTS					
EIDST	FLOOR														
101	APPARATUS BAY	(E)	RB-1	PT-1	PT-1	PT-1	PT-1	(E)	PT-1						
102	TURN OUT	(E)	RB-1	PT-1	PT-1	PT-1	PT-1	(E)	PT-1						
03	LOBBY	CONC-1	RB-1	PT-1	PT-1	PT-1	PT-1	(E)	PT-1						
104	DORM 1	CONC-1	RB-1	PT-1	PT-1	PT-1	PT-1	GB	PT-1						
105	KITCHEN/LIVING	CONC-1	RB-1	PT-1 / PT-2	PT-1	PT-1 / PT-2	PT-1 / PT-2	GB, (E)	PT-1						
06	STORAGE	CONC-1	RB-1	PT-1	PT-1	PT-1	PT-1	(E)	PT-1						
107	RR	CONC-2	RB-1	PT-2	PT-2	PT-2	PT-2	(E)	PT-1	EPOXY PAINT					
108	CORRIDOR	CONC-1	RB-1	PT-1		PT-1	PT-1	GB	PT-1						
09	DORM 2	CONC-1	RB-1	PT-1	PT-1	PT-1	PT-1	GB	PT-1						
110	DORM 3	CONC-1	RB-1	PT-1	PT-1	PT-1	PT-1	GB	PT-1						
111	STORAGE	CONC-1	RB-1	PT-1	PT-1	PT-1	PT-1	GB	PT-1						
112	RR	CONC-2	RB-1	PT-2	PT-2	PT-2	PT-2	(E)	PT-1	EPOXY PAINT					
113	LAUNDRY	CONC-2	RB-1	PT-1	PT-1	PT-1 / FRP-1	PT-1 / FRP-1	(E)	PT-1	FRP, SEE INTERIOR ELEVATIONS					

											DOOR SO	CHEDUL	.E			
			DO	OR		-		FRAME	<u> </u>		DETAILS					
DOOR NUMBER	TYPE	WIDTH	неіснт	THICKNESS	CONSTRUCTION	FINISH	TYPE	CONSTRUCTION	FINISH	SILL	JAMB	НЕАD	GLAZING	FIRE RATING	HARDWARE	NOTES
FIRST FLOO	R															
		1' - 10 3/8"	6' - 9"													
101A	(E)	12' - 0"	11' - 0"	0' - 1 3/4"	(E)	PT	(E)	(E)					(E)		01	EXISTING APPARATUS BAY DOOR
101B	(E)	12' - 0"	11' - 0"	0' - 1 3/4"	(E)	PT	(E)	(E)					(E)		01	EXISTING APPARATUS BAY DOOR
101C	(E)	3' - 0"	6' - 8"	0' - 1 3/4"	(E)	PT	(E)	(E)	PT				(E)		11	PAINT EXISTING DOOR (INTERIOR SIDE)
101D	(E)	12' - 0"	11' - 0"	0' - 1 3/4"	(E)	PT	(E)	(E)					(E)		01	EXISTING APPARATUS BAY DOOR
102	(E)	3' - 0"	6' - 8"	0' - 1 3/4"	(E)	PT	(E)	(E)	PT				` ′		03	PAINT EXISTING DOOR, REPLACE HARDWARE TO BE ACCESSIBLE
103A	(E)	3' - 0"	6' - 8"	0' - 1 3/4"	(E)	PT	(E)	(E)	PT						02	PAINT EXISTING DOOR (INTERIOR SIDE), REPLACE HARDWARE
103B	(E)	3' - 0"	6' - 8"	0' - 1 3/4"	(E)	PT	(E)	(E)	PT						04	PAINT EXISTING DOOR
104	A	3' - 0"	6' - 8"	0' - 1 3/4"	WD-S	PT	1	WĎ	PT					20	05	CLOSER, ACOUSTIC SEALS AND THRESHOLD
105B	(E)	3' - 0"	6' - 8"	0' - 1 3/4"	(E)	PT	(E)	(E)	PT						04	PAINT EXISTING DOOR
106	(E)	2' - 8"	6' - 8"	0' - 1 3/4"	(E)	PT	(E)	(E)	PT						06	PAINT EXISTING DOOR, REPLACE HARDWARE TO BE ACCESSIBLE
107	A	2' - 6"	6' - 8"	0' - 1 3/4"	WD-S	PT	1	WD	PT						07	
109	Α	3' - 0"	6' - 8"	0' - 1 3/4"	WD-S	PT	1	WD	PT					20	05	CLOSER, ACOUSTIC SEALS AND THRESHOLD
110	А	3' - 0"	6' - 8"	0' - 1 3/4"	WD-S	PT	1	WD	PT					20	05	CLOSER, ACOUSTIC SEALS AND THRESHOLD
111	Α	3' - 0"	6' - 8"	0' - 1 3/4"	WD-S	PT	1	WD	PT						08	
112	(E)	3' - 0"	6' - 8"	0' - 1 3/4"	(E)	PT	1	(E)	PT						09	PAINT EXISTING DOOR, HINGE SIDE FLIPPED AND REVERSE SWING, REPLACE HARDWARE TO BE ACCESSIBLE
113	(E)	3' - 0"	6' - 8"	0' - 1 3/4"	(E)	PT	(E)	(E)	PT						04	PAINT EXISTING DOOR
SECOND FL	OOR	•	•	<u>'</u>									•	•		
202A	Α	3' - 0"	6' - 8"	0' - 1 3/4"	WD-S	PT	1	WD	PT						10	
202B	А	2' - 0"	4' - 0"	0' - 1 3/4"	(E)	PT	(E)	(E)	PT						(E)	PAINT EXISTING ATTIC ACCESS DOOR

SCHEDULE NOTES	
 A. PROVIDE SAFETY GLAZING PER CODE. B. SWINGING DOOR DIMENSIONS ARE OPENING SIZE. CONTRACTOR TO COORDINATE PANEL SIZE AND ROUGH OPENING DIMENSIONS. C. SEE FRAME TYPES FOR TYPICAL DETAILS UNLESS NOTED OTHERWISE. 	
WD = WOOD HM = HOLLOW METAL PT = PAINT	

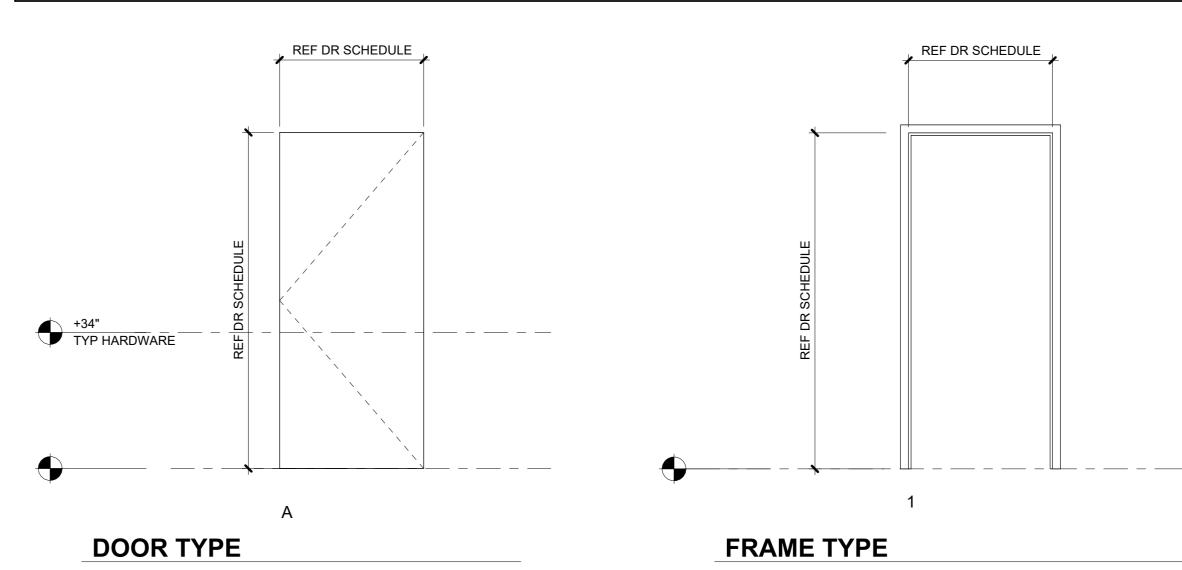

	DESCRIPTION	MANUFACTURER	MODEL	FINISH	COMMENTS
1	ROUND DOWNLIGHT	HALO	HLBPH6	WHITE	3500K
2	LINEAR SURFACE MOUNT	CORELITE	RZL-WL	WHITE	4000K
3	ROUND SURFACE MOUNT	HALO	FM159S1EWHR	WHITE	3500K
4	ROUND SURFACE MOUNT	HALO	SMX14RLS	WHITE	3500K
5	CANLESS RECESSED	HALO	RL4-DM	WHITE	WET LOCATION
6	LINEAR SURFACE MOUNT	METALUX	LBLED	WHITE	8' SYMMETRIC
7)	HORIZ. WALL SCONCE	SHAPER	605-W-25 AND 605-W-49	WHITE	3000K
8	EXTERIOR SPOT LIGHT	-	-		LED REPLACEMEN
-9	EXTERIOR SPOT LIGHT	-	-		LED REPLACEMEN
OT I AL	1	ED AND INSTALLED BY CONTR	ACTOR		EED NEI ENGEMEN
,OIVI	IMICINIO				



2525 E Burnside St. Portland, OR 97214

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Clackamas Fire **District:** Station 12 Job Number: #24115

18081 S Harding Rd Oregon City, OR 97045



BID SET PERMIT SET

ISSUE Drawing:

SCHEDULES AND FINISHES

01.06.25

12.20.24

DATE

Sheet No:

ABBREVIATIONS

ANCHOR BOLT A.B. A.F.F. ABOVE FINISH FLOOR ALTERNATE ARCH ARCHITECTURAL BLDG BUILDING BLOCKING BLKG BEAM **BOUNDARY NAILING** B.O.F.

BOTTOM OF FOOTING

BOT BOTTOM BRG BEARING BTWN BETWEEN CAMBER **CEMENT FIBER DECK** COLD JOINT CENTER LINE CLR CLEAR CMU CONCRETE MASONRY UNIT CNTR CENTER COL COLUMN CONCRETE

CONN CONNECTION CONT CONTINUOUS COORD COORDINATE C.P. COMPLETE PENETRATION CTSK COUNTERSINK DOUBLE DETAIL DOUGLAS FIR DIAMETER DIMENSION

DIRECTION DEAD LOAD DEEP DRWG DRAWING EACH **EXPANSION JOINT** EL or ELEV ELEVATION EMBED EMBEDMENT **EDGE NAILING** E.N. EACH WAY EXIST or (E) **EXISTING EXPANSION EXTERIOR**

FACE FOUNDATION FINISH FLOOR FINISH FLR FLOOR FACE OF CONCRETE F.O.M. FACE OF MASONRY F.O.S. FACE OF STUD F.O.SH. FACE OF SHEATHING FAR SIDE

FOOTING GAGE OR GAUGE GALV GALVANIZED GEN GENERAL GLUE LAMINATED GLUE LAMINATED BEAM GYP WALL BD GYPSUM WALLBOARD HEADED CONCRETE ANCHOR HDR HEADER HGR HANGER

HORIZ HORIZONTAL HFIGHT INSULATED CONCRETE FORM INTERIOR INFORMATION JOIST JOINT LBS or # POUNDS LIVE LOAD

LONG LEG HORIZONTAL LONG LEG VERTICAL LAMINATED STRAND LUMBER LAMINATED VENEER LUMBER MANUF MANUFACTURER MAT'L MATERIAL MAX MAXIMUM M.B. MACHINE BOLT MBR MEMBER MECH MECHANICAL

MINIMUM NEW N.A. **NEUTRAL AXIS** N.S. NON-SHRINK N.T.S. NOT TO SCALE ON CENTER OPPOSITE HAND O.H. or OPP P.A.F. POWDER ACTUATED FASTENER PERF PERFORATED

PLCS **PLACES** PLYWD PLYWOOD PARTIAL PENETRATION POUNDS PER SQUARE FOOT POUNDS PER SQUARE INCH PARALLEL STRAND LUMBER PSL PRESSURE TREATED REINF REINFORCEMENT/REINFORCING

REQ'D REQUIRED SCHED SHT SCHEDULE SHEET SHTG SHEATHING SIM SIMILAR S.O.G. SLAB ON GRADE SPECS SPECIFICATIONS SQUARE STAINLESS STEEL S.S. STD STANDARD STIFF STIFFENER STL STEEL STRUCT STRUCTURAL SW SHEAR WALL THREADED

THRD T.O.C. TOP OF CONCRETE T.O.F. TOP OF FOOTING T.O.J. TOP OF JOIST T.O.S. T.O.P. TOP OF SLAB OR STEEL TOP OF PILE T.O.P.C. TOP OF PILE CAP T.O.W. TOP OF WALL TONGUE AND GROOVE TYP TYPICAL U.O.N. UNLESS OTHERWISE NOTED **VERT** VERTICAL

W.J. WET JOINT W.W.F. WELDED WIRE FABRIC WITHOUT POUNDS or NUMBER PLUS or MINUS

STRUCTURAL NOTES

01.0 GENERAL NOTES

1. These notes set minimum standards for construction. The drawings govern over the Structural Notes to the extent shown. 2. Contractor shall verify all dimensions and conditions on drawings and in field. Coordinate locations of openings through floors, roofs and walls with architectural, mechanical and electrical plans. Notify owner's

representative of any discrepancies. 3. Construction means, methods and all necessary temporary support prior to completion of vertical and

lateral load systems is the sole responsibility of the contractor. 4. Compliance with all safety and OSHA requirements is the sole responsibility of the contractor. 5. All work shall be in compliance with 2022 edition of the "Oregon Structural Specialty Code- (OSSC) 2018 edition of the "International Building Code" (IBC) as amended by all other state and local codes, permits, and building department requirements that apply.

6. Where reference is made to ASTM, AISC, ACI or other standards, Code referenced issue shall apply. 7. Special inspection shall be provided as required by the OSSC and outlined in the special inspection section of the structural drawings. 8. Design Criteria:

o. Design Officia.					
Design Criteria					
Table 1604.5	Risk Catogory	IV			
Roofs	Dead load	15 psf			
	Snow load (minimum)	20 psf x I _S			
	Ground snow load, P _g	10 psf			
	Flat-roof snow load, P _f	10 psf			
	Snow exposure factor, C _e	1.2			
	Snow importance factor, I _s	1.2			
	Thermal factor, C _t	1.0			
Floors	Dead load fitness room / lounge	22.2 psf /10 psf			
	Live load fitness room / lounge	100 psf / 50 psf			

9. Details shown on the drawings are intended to apply at all similar conditions and locations.

10. Do not scale information from drawings.

03.0 CONCRETE

1. Strength: Average concrete strength as determined by job cast, lab cured cylinder shall be per the table below plus increase depending upon the plant's standard deviation as specified in ACI 318. Four (4) test cylinders meeting ACI 318 Section 26.12 shall be taken at each pour. One (1) cylinder shall be tested at 7 days and three (3) cylinders shall be tested at 28 days. Test reports are to include minimum and maximum

e box temperatures.					
Use ³	Strength, f'c psi Max		/C ratio	Max	EXP
Ose	At 28 Days	Non AE	AE	Aggregate	CLASS ²
slab on grade	2,500	0.421		1-1/2"	
Water-cement ratio may be increased to 0.45 if adhesive applied finishes are not present					

1. Water-cement ratio may be increased to 0.45 if adhesive applied finishes are not present 2. Use exposure case 0 for all categories not listed.

3. Uses indicated are for concrete elements identified on the structural drawings.

or edge margared are for definition administration and are discontinuing.					
Total Air Content for Co Cycles of Freezing	•				ious Material Content for Floors
Nominal Maximum	Target Air Content			Nominal Maximum	Minimum Cementitious
Aggregate Size, in	, in F1 F2 & F3 Aggreg	Aggregate Size, in	material content, lb/yd ³		
3/8	6.0%	7.5%		3/8	610
1/2	5.5%	7.0%		1/2	610
3/4	5.0%	6.0%		3/4	540
1	4.5%	6.0%		1	520
1 1/2	4.5%	5.5%		1 1/2	470

MINIMUM Mix Requirements:

a. Rough aggregate size for slabs on grade shall be 1-inch minus for slabs less than 5-inches thick and

1-1/2-inch minus for slabs 5-inches and thicker.

b. Slabs-on-grade, floor slabs and beams poured integral with floor slabs shall have a minimum cementitious material content as noted in the table based on nominal maximum size of aggregate used. c. Add supplementary cementitious material to slab on grade and exposed wall concrete mixes (except at slabs to receive a polish finish - refer to project specifications). Supplementary cementitious material to be slag or fly ash. Do not add fly ash to air entrained mixes without making adjustments for potential loss of air. Limits on maximum percentage of total cementitious material by mass to be 20% for fly ash conforming to ASTM C618 with loss on ignition of 3% or less and 50% for slag conforming to ASTM C989 and added per ASTM C595. Include supplementary cementitious material in the water cement ratio. Supplementary cementitious material may be added to other concrete mixes and included in the water cement ratio but is

not to be used as part of the minimum cement content. Contractor to consider late strength development and finishing for mixes with supplementary cementitious material. d. Design slump: Minimum 3", maximum 9". Field variation from design slump +1/2 inch to -1 inch. When

concrete is to be pumped add plasticizers and provide a new mix design to increase slump to a pumpable mix. Do not add water at the jobsite unless authorized by the concrete supplier. e. Air Entrainment: For mix designs subject to freezing-and-thawing exposure classes F1, F2 and F3 shall be air entrained per the table. Where $f'c \ge 5000$ psi, reduction of air content per the table by 1.0 percentage

point is permitted. f. Admix: Water reducing admix (Pozzolith/Polyheed/Rheobuild or equal). g. All admixtures are to be from the same manufacturer unless evidence is submitted verifying compatibility of multiple source admixtures.

2. Place and cure all concrete per ACI codes and standards. 3. Sleeves, pipes or conduits of aluminum shall not be embedded in structural concrete unless effectively

03.1 REINFORCING (CONCRETE)

1. All reinforcing steel shall be ASTM A615, Grade 60.

Tack welding of rebar is not permitted. 3. Fabricate reinforcing steel according to ACI 315, Details and Detailing of Concrete Reinforcement. Install reinforcing per CRSI MSP-1, ACI 301 and ACI 318. 4. Splices in reinforcing shall be lapped 45 diameters or 2'-0", whichever is greater, and shall be staggered at least 4 feet at alternate bars.





1. All lumber species and grade to be as follows:

1.7 th familiar appealed and grade to be as follows.				
Joists, beams and stringers (2x & 4x)	DF #2 K.D 15 percent M.C.			
6" nominal & greater beams and stringers	DF #1-19 percent M.C.			
Bucks, blocking, bridging and misc.	DF #3 or better			
Structural 2x studs	DF #2-19 percent M.C.			
Plates, sills and headers for wall framing	DF #2 K.D 15 percent M.C.			
Posts	DF #1 - 19 percent M.C.			
Sills, ledgers, plates, etc embedded in or in contact with concrete, not exposed to weather	Pressure treated Hem Fir #2 KDAT AWPA UC2 (ACZA Not Allowed)			
Where moisture content is provided, do not install framing if members exceed noted moisture content				

2. All engineered wood to meet the following criteria: Material Grade Fb Fv 2,500 psi Laminated Veneer Lumber (LVL) 2.0E

Approved manufacturers: RedBuilt LLC, LP Building Products or iLevel, a Weyerhaeuser business. 3. Sheathing shall be APA Rated plywood Sturd-I-Floor, C-D grade, Exposure 1 with Performance Category and Span Rating as noted below. Each sheet shall bear an APA stamp. Install floor sheathing per plans with face grain perpendicular to supports and stagger end joints. Glue floor sheathing per plans. Protect all sheathing from weather damage and moisture. Replace all buckled or soft sheets. Do not cover sheathing with permanent finishes until sheathing has a moisture content of less than 19%.

Location	Performance Category	Span Rating
Floors	23/32 T&G	24 oc
4. Framing anchors, joist hangers, post caps, etc., manufacturer's recommendations for tabulated ma	• •	-

Framing anchors attaching to pressure treated lumber shall be Z Max coated or hot dipped galvanized and attached with hot dipped galvanized (2.0 oz per square foot) or stainless steel nails or screws. Framing anchors installed at exterior locations exposed to weather are to be stainless steel with stainless steel

5. All nailing shall be per IBC Table 2304.10.2. Nails called for on the drawings shall be common for plywood nailing; box nails for framing; and type recommended by manufacturer for maximum capacity of hangers and connectors. Nail heads shall not penetrate the face veneer of plywood panels.

6. Nails, bolts or lags in pressure treated lumber shall be hot dipped galvanized or stainless steel. 7. Cutting and notching of joists not allowed. A one-inch (1") diameter hole may be drilled in the center 1/3 of width of member depth. All other holes shall be approved.

8. Studs may be notched in the lower 1/5 of the height of stud for electrical and plumbing pipes, but no part of the notch is to be deeper than 25 percent of width of stud. Holes of diameters up to 1/3 of width of stud may be drilled in stud but not in center 1/3 of height. The edges of drilled holes are to be at least 5/8 inch from the face of the stud.

9. Provide deflection space over all non-bearing walls.

10. Lag bolts shall be installed in lead holes as follows: a. The lead hole for the shank shall have the same diameter as the shank and the same depth as the length

of the unthreaded shank. b. The lead hole for the threaded portion shall have a diameter equal to 70 percent of the shank diameter and a length equal to at least the length of the threaded portion.

c. The threaded portion or the screw shall be inserted in its lead hole by turning with a wrench, not by driving with a hammer. Soap or other lubricants may be used on the screws or in the lead hole to facilitate insertion and prevent damage to the screw.

STRUCTURAL NARRATIVE

Structural work is limited to floor improvements for conversion of a portion of the second floor to a fitness room, new stair framing, new bearing wall at the stairs, new second floor partial wall guardrail, and new beam at portion of removed bearing wall. There are no modifications to the existing structures main lateral force resisting systems.

DRAWING INDEX DRAWING NUMBER DRAWING NAME STRUCTURAL NOTES AND S1.01 ABBREVIATIONS FIRST FLOOR & SECOND FLOOR S2.01



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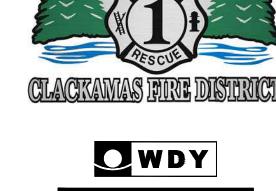


Clackamas Fire District: Station 12

18081 S Harding Rd Oregon City, OR 97045

Job Number:





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FRAMING PLAN S3.01 DETAILS

ABBREVIATIONS

STRUCTURAL

NOTES AND

PERMIT SET

ISSUE


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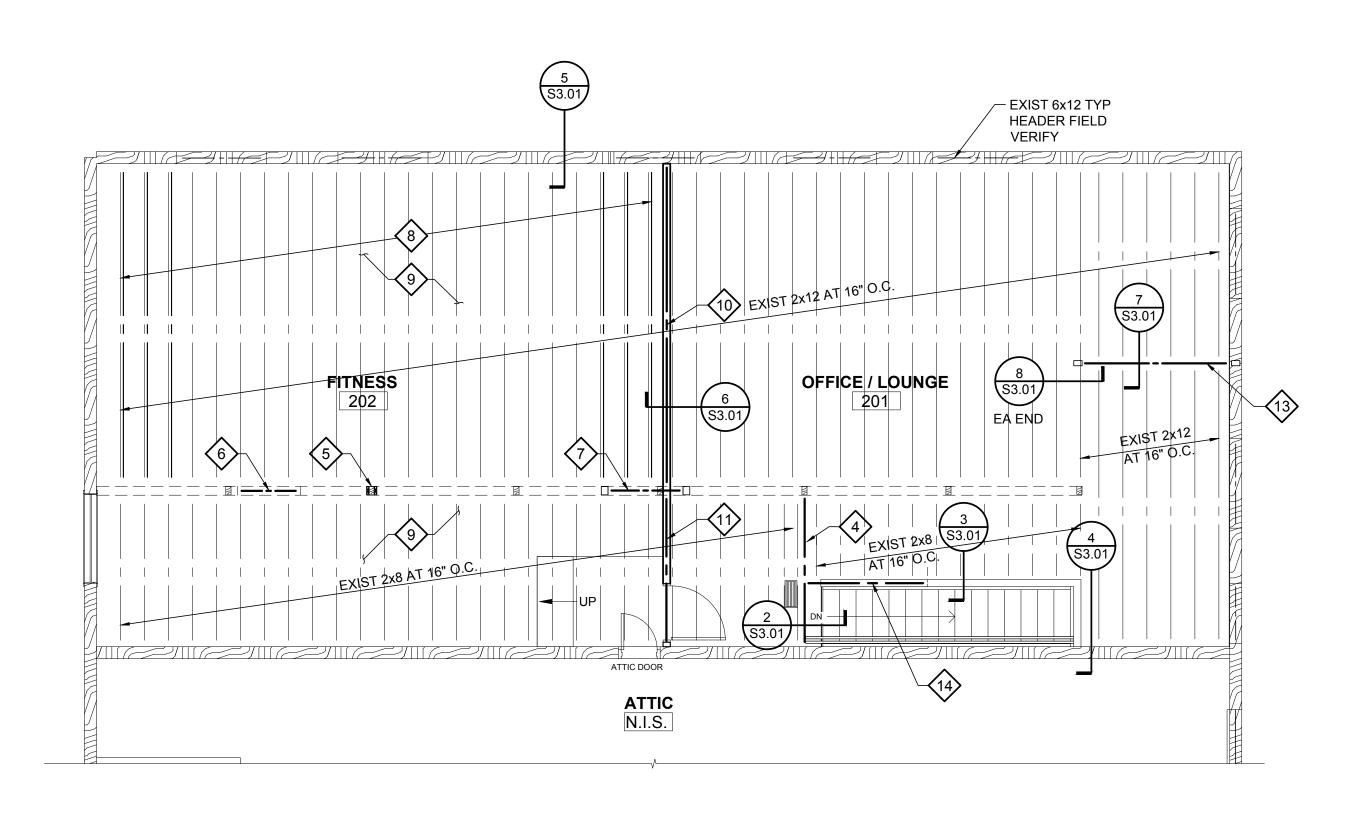
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S1.01

01.06.25

12.20.24



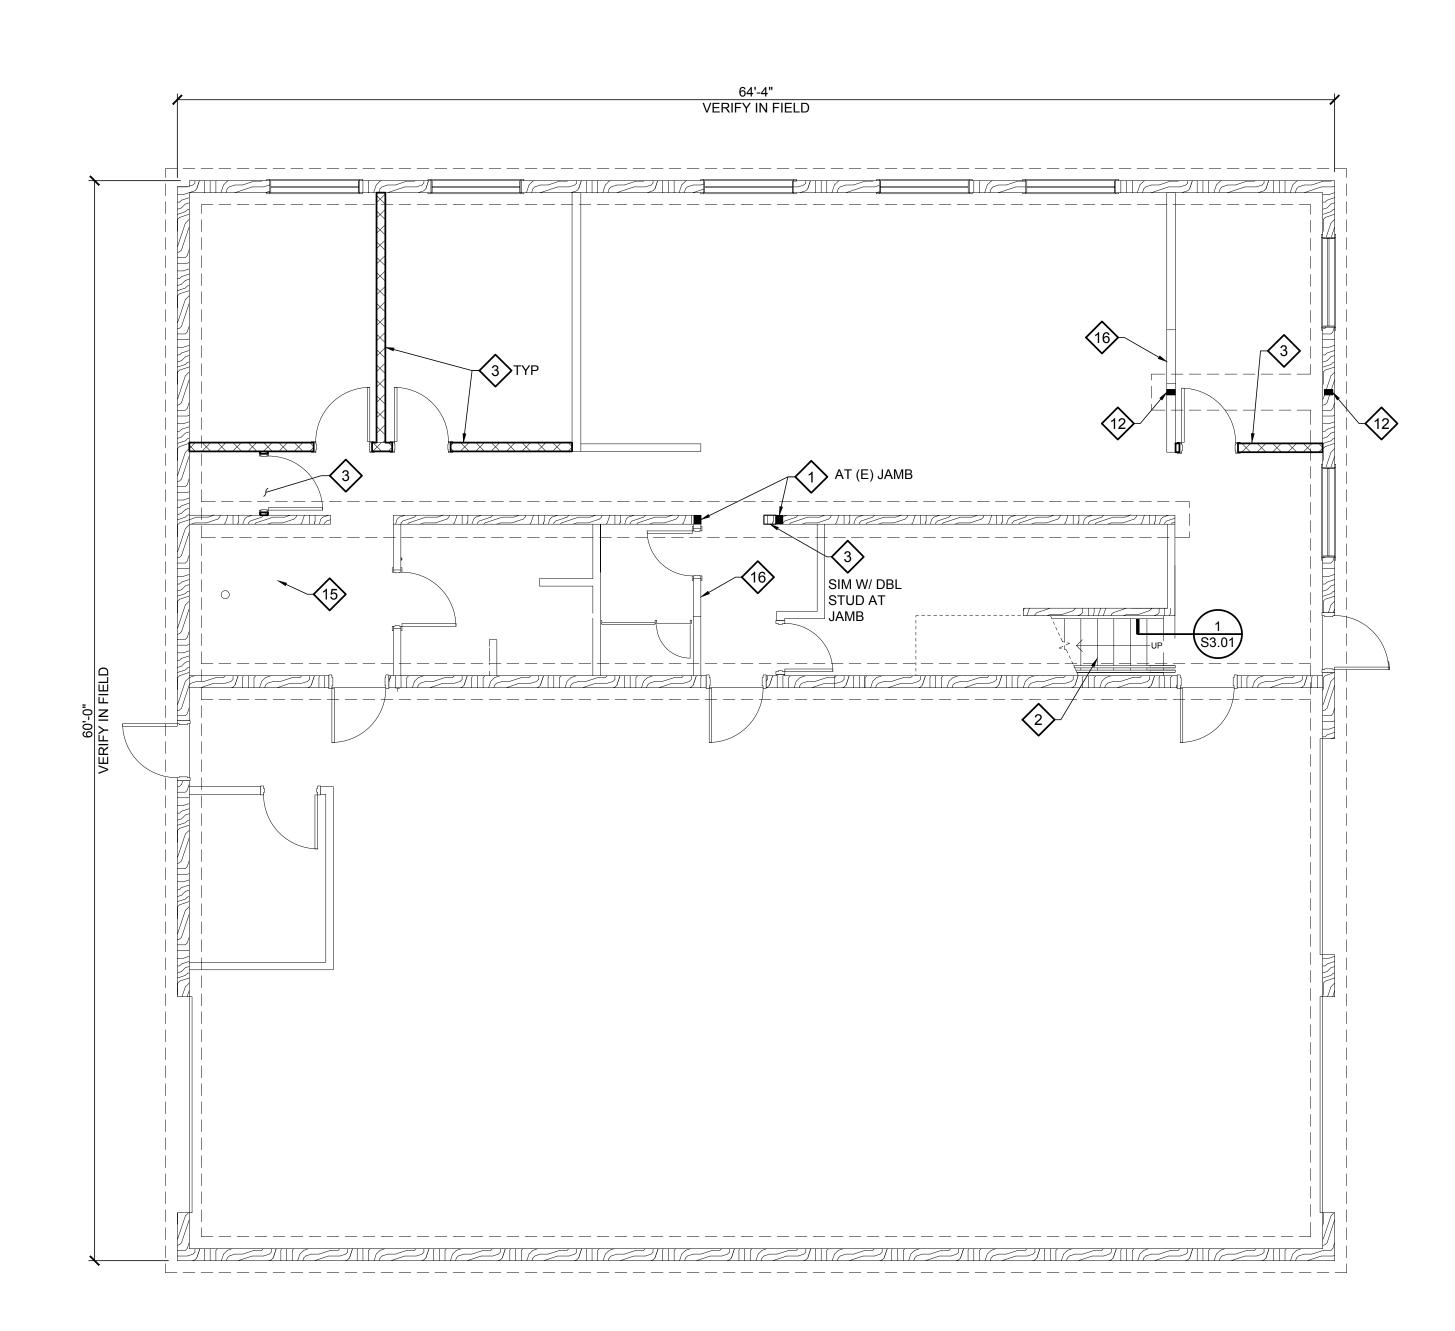

NEW NON-STRUCTURAL PARTITION WALL SEE ARCH AND NOTE 3

EXISTING STRUCTURAL WALL

EXISTING

NON-STRUCTURAL

WALL

STRUCTURAL KEY NOTES:

NEW JAMB WITH (2) 2x6 TRIMMER STUD AND (1) 2x6 KING STUD.

NEW FULL LENGTH STRINGERS AT 8" ON CENTER CUT FROM 1-3/4 x 14 LVL

AT NEW PARTITION WALLS PROVIDE 3/4" DEFLECTION SPACE BETWEEN

AT NEW PARTITION WALLS PROVIDE 3/4" DEFLECTION SPACE BETWEEN TOP PLATE AND BOTTOM OF JOISTS. USE DOUBLE TOP PLATE WITH SIMPSON SDPW19600 AT 32" ON CENTER TO EXISTING JOISTS. USE 0.157" DIAMETER POWDER ACTUATED FASTENERS AT 32" ON CENTER AT SILL WITH 1" MINIMUM CONCRETE EMBEDMENT.

NEW (2) 1-3/4 x 7-1/4 LVL HEADER AT TOP OF STAIR STRINGERS. SIMPSON LUS48 NORTH END AND 1-1/2" BEARING ON TOP PLATES SOUTH END.

ADD FULL HEIGHT 2x6 WEST AND EAST SIDES OF EXISTING POST. NAIL LAMINATE WITH 16D NAILS AT 12" ON CENTER.

6 FIELD VERIFY MINIMUM (2) 2x10 HEADER. NOTIFY ARCH/ENGR IF DIFFERENT THAN SHOWN.

NEW (3) 1-3/4 x 11-1/4 LVL HEADER NAIL LAMINATED W/ 16d AT 12" O.C. TOP & BOT EACH FACE

SISTER NEW, FULL LENGTH 1-3/4 x 11-1/4 LVL TO EACH EXISTING 2x12 JOIST AT 16" ON CENTER AT FITNESS AREA. NAIL LAMINATE WITH 16D NAILS AT 12" ON CENTER, 2-1/2" FROM TOP AND BOTTOM.

ADD (1) LAYER OF 23/32" CDX T&G PLYWOOD TO FLOOR IN FITNESS AREA. STAGGER JOINTS WITH EXISTING FLOOR SHEATHING AND NAIL WITH 10D AT 6" ON CENTER AT SUPPORTED EDGES AND 12" ON CENTER INTERMEDIATE SUPPORTS. GLUE TO EXISTING SHEATHING AT JOIST LAYOUT.

NEW DOUBLE 1-3/4 x 11-1/4 UNDER NEW WALL. NAIL LAMINATE WITH 16D NAILS AT 12" ON CENTER, 2-1/2" FROM TOP AND BOTTOM. 1-1/2" MINIMUM BEARING ON WALL TOP PLATE EACH END.

NEW 1-3/4 x 7-1/4 UNDER NEW WALL. 1-1/2" MINIMUM BEARING ON WALL TOP PLATE SOUTH END AND SIMPSON HU7 NORTH END.

NEW 4x POST CENTER UNDER BEAM ABOVE MAX STUD DEPTH

NEW (2) 1-3/4 x 11-1/4 LVL BEAM NAIL LAMINATE W/ 16d AT 12" O.C. TOP & BOT

NEW 1-3/4 x 7-1/4 LVL WITH SIMPSON HU7 WEST END AND 3" BEARING ON EXISTING WALL EAST END. STRAP TO EXISTING RIM W/ SIMPSON LSTA9

EXISTING 4" CONCRETE SLAB ON GRADE - SEE 9/S3.01 FOR SLAB POUR BACK AT PLUMBING TRENCHES

INFILL EXISTING OPENING W/ STUDS TO MATCH EXISTING STUDS AND SPACING

2 SECOND FLOOR FRAMING PLAN \$2.01 3/16" = 1'-0"



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Clackamas Fire
District:
Station 12
Job Number: #241

EXPIRES: 12-31-2025

Job Number: #2 18081 S Harding Rd Oregon City, OR 97045



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1 FIRST FLOOR PLAN \$2.01 3/16" = 1'-0"

BID SET
PERMIT SET

ISSUE Drawing:


FIRST &
SECOND FLOOR
FRAMING
PLANS

Sheet No:

S2.01

01.06.25

12.20.24

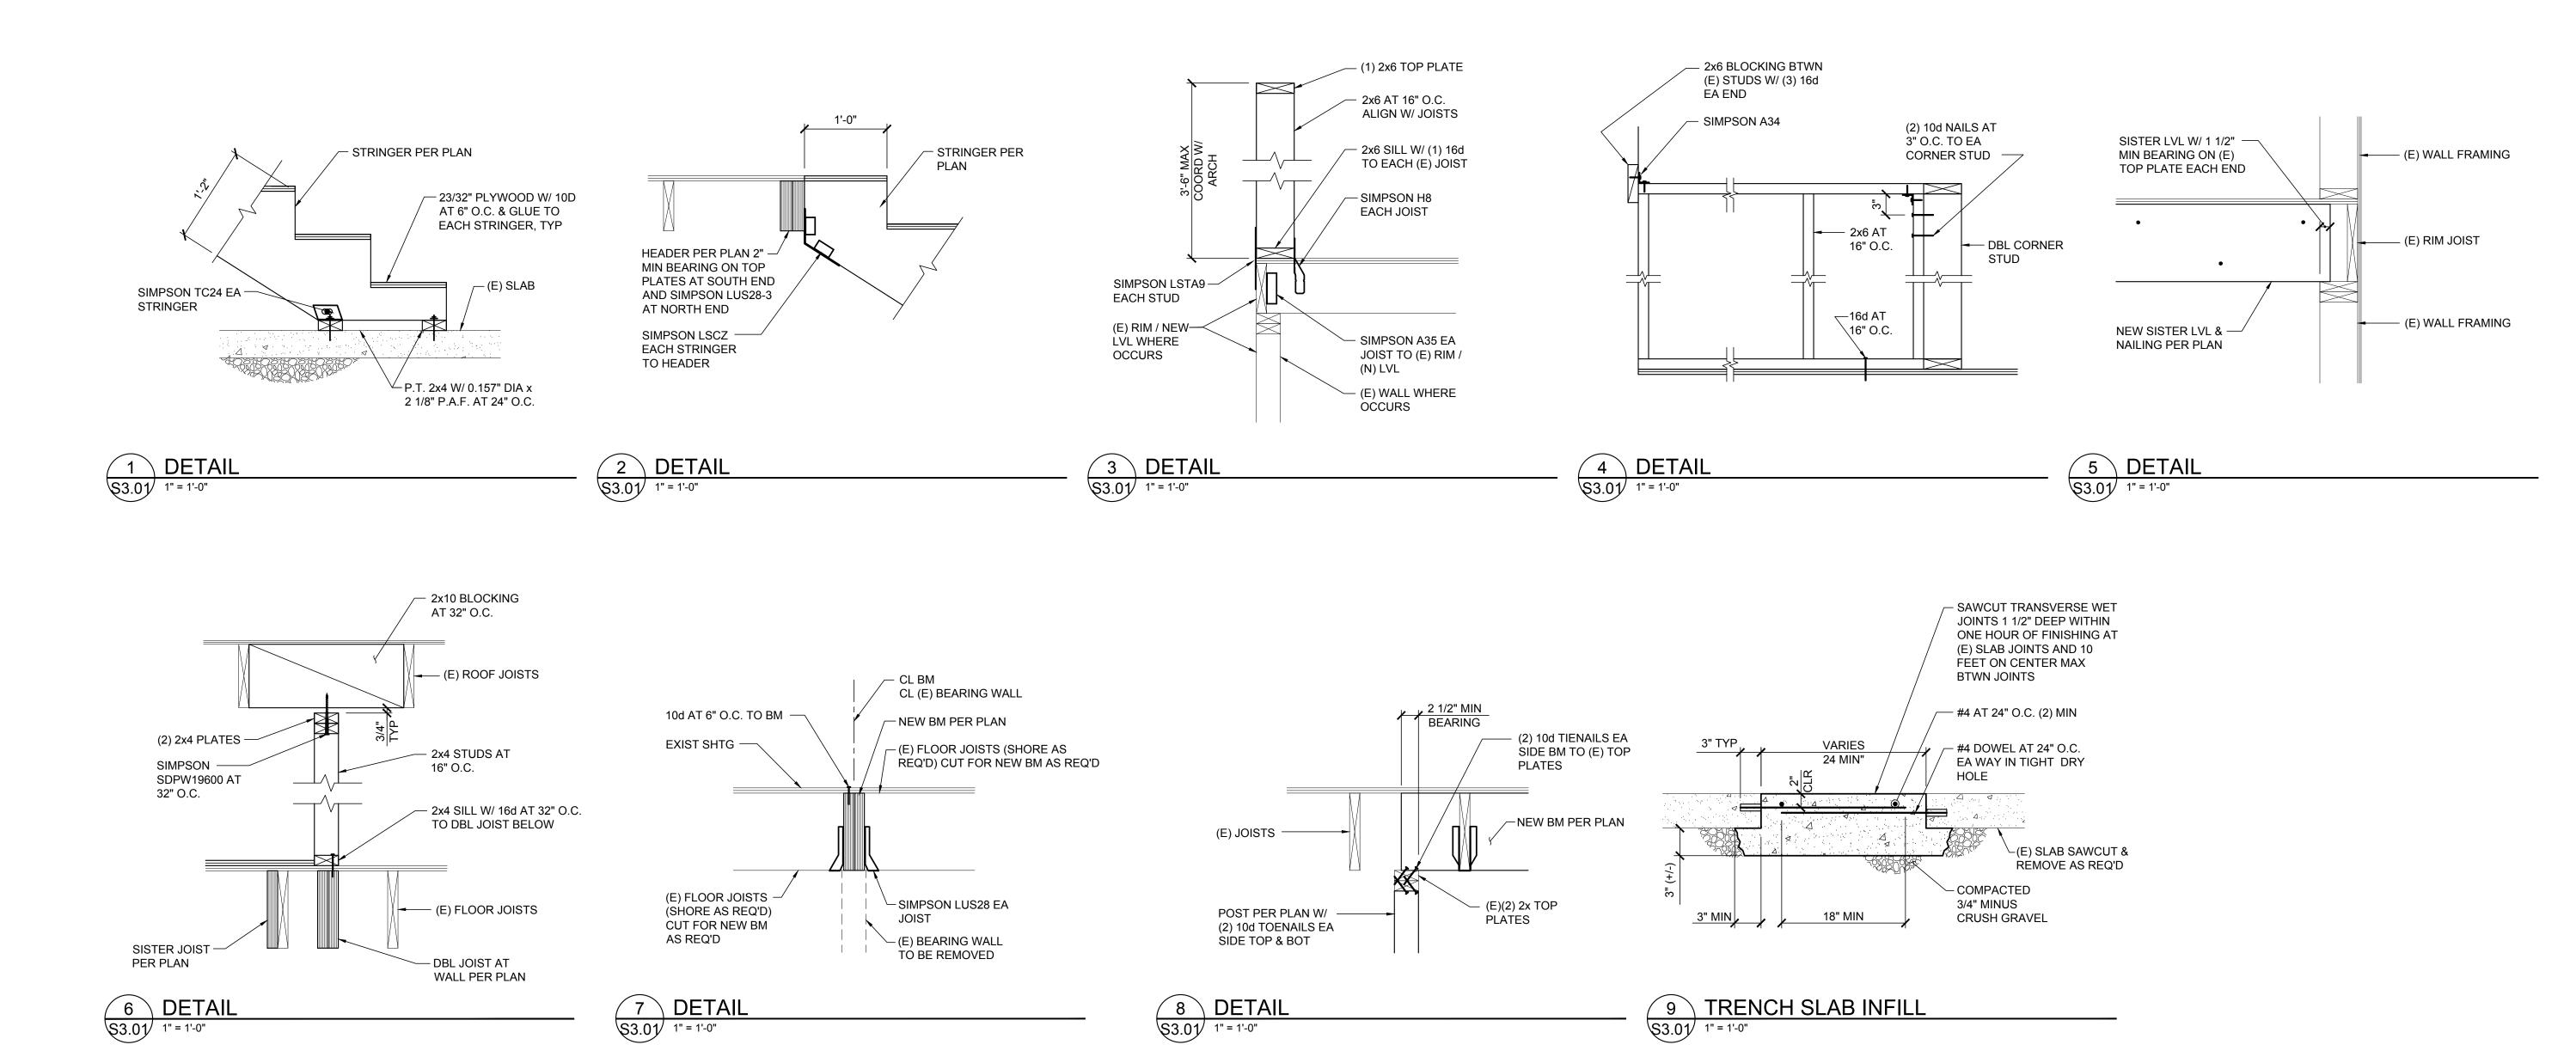





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DETAILS

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